# WESTERN ILLINOIS MUSEUM

# HVAC AND PLAN UPGRADES 2022

FOR:
WESTERN ILLINOIS MUSEUM
201 S. LAFAYETTE STREET
MACOMB, ILLINOIS 61455

ISSUANCE: JANUARY 27, 2023 ISSUED FOR BID







WESTERN ILLINOIS MUSEUM

201 S. LAFAYETTE ST. MACOMB, IL 61455

OWNED

Western Illinois Musuem 201 S. Lafayette Street Macomb, IL 61455 Contact: Sue Scott Tel: 309.837.2750

ARCHITECT

**HPZS** 

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NO.	DATE	REMARKS

Seal/Drawing Status:

NOT FOR CONSTRUCTION

COVER SHEET

PROJECT NUMBER: 2206-01

DATE: 01/27/2023


DRAWN BY: AS

CHECKED BY: HZ

SCALE: PER DWG

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WELDED WIRE FABRIC

#### **GENERAL CONSTRUCTION NOTES**

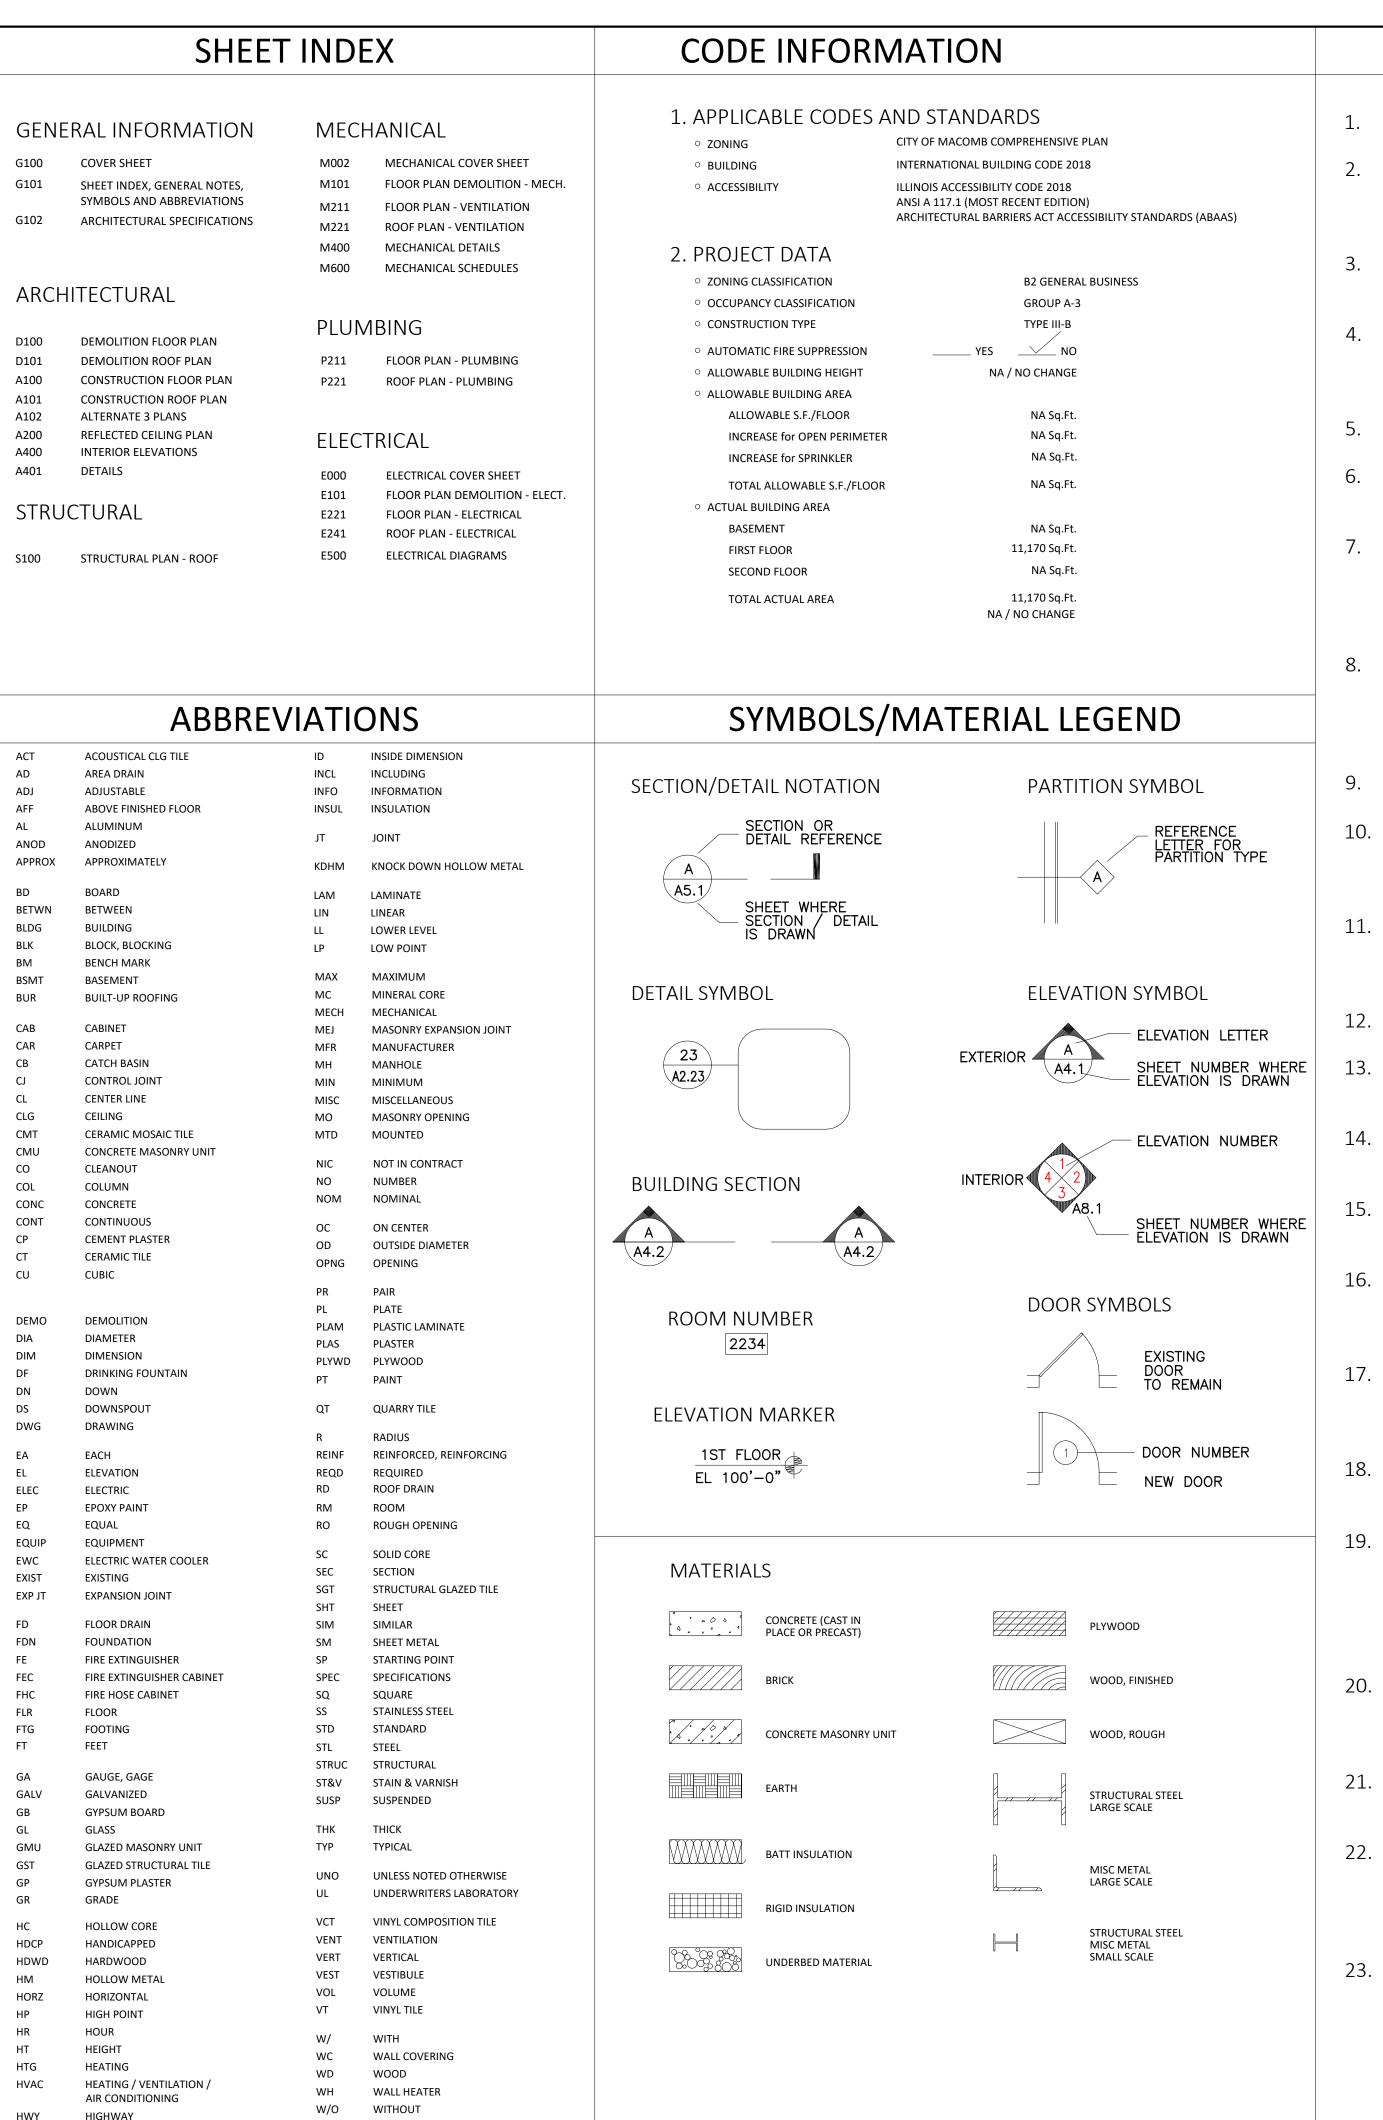- 1. THIS DRAWING SET IS NOT FOR CONSTRUCTION.
- 2. CONTRACTORS SHALL COMPLY WITH APPLICABLE LOCAL, STATE, AND FEDERAL CODES AND REGULATIONS PERTAINING TO SAFETY OF PERSONS, PROPERTY AND ENVIRONMENTAL PROTECTION.
- 3. CONTRACTORS SHALL COORDINATE AND COOPERATE IN OBTAINING ALL PERMITS AND INSPECTIONS RELATING TO THIS SCOPE OF WORK.
- 4. CONTRACTORS SHALL VERIFY AND BE RESPONSIBLE FOR ALL EXISTING CONDITIONS AND DIMENSIONS IN THE FIELD. HPZS SHALL BE NOTIFIED OF ANY DISCREPANCIES BEFORE PROCEEDING WITH ANY WORK.
- 5. ALL DIMENSIONS ARE SHOWN TO FINISH UNLESS OTHERWISE INDICATED
- 6. DRAWINGS SHALL NOT BE SCALED. NOTED DIMENSIONS GOVERN. LARGE SCALE DETAILS GOVERN OVER SMALLER SCALED DRAWINGS.
- 7. WHERE EXISTING CASEWORK HAS BEEN REMOVED, PATCH ALL WALLS, FLOORS AND CEILING FACES AND ALL RELATED TRIM AS REQUIRED FOR SMOOTH FINISH FOR PAINT. ALL NEW GYPSUM WALL BOARD WALLS SHALL BE FINISHED TO MATCH FINISH OF EXISTING GYPSUM BOARD WALL PARTITIONS.
- 8. ALL EXISTING CONSTRUCTION SHALL BE PROTECTED AND THE CONTRACTOR SHALL BEAR RESPONSIBILITY FOR ALL DAMAGES TO EXISTING CONSTRUCTION INDICATED TO REMAIN. ITEMS DAMAGED AS A RESULT OF ANY CONTRACTOR'S WORK SHALL BE REPLACED OR REPAIRED IN FULL EXTENT BY THE CONTRACTOR.
- 9. REFER TO REFLECTED CEILING PLANS FOR WORK AT CEILINGS.
- 10. WHERE EXISTING DOORS AND/OR DEVICES ARE REMOVED, PATCH ALL WALLS, FLOORS, AND CEILINGS AS REQUIRED FOR SMOOTH FINISH. PATCH TO MATCH EXISTING ADJACENT SURFACE.
- 11. ALL SALVAGED TRIM SHALL BE ASSESSED FOR REINSTALLATION BY ARCHITECT. WHERE SALVAGED TRIM CANNOT BE REINSTALLED, NEW TRIM TO MATCH EXISTING SHALL BE FURNISHED AND INSTALLED.
- 12. ALL EXPOSED CONDUIT, PIPING, DUCTWORK, ETC. TO BE PAINTED.
- 13. PROVIDE TEMPORARY SUPPORT FOR ALL EXISTING PIPING, DUCTWORK, AND CONDUIT TO REMAIN DURING DEMOLITION OF SURROUNDING SURFACES.
- 14. PROVIDE HANGER SUPPORT FOR ALL PIPING AND CONDUIT AS REQUIRED DUE TO REMOVAL OF SURROUNDING SURFACES.
- 15. FURNISH AND INSTALL ACCESS PANEL AT ALL CONCEALED VALVE LOCATIONS IN WALLS, CEILINGS, AND SOFFITS.
- 16. REFER TO ALL THE ENGINEERING PLANS FOR QUANTITIES AND SIZES. CONTRACTOR SHALL PROVIDE ALL ACCESS DOORS AT LOCATIONS REQUIRING ACCESS TO RECESSED EQUIPMENT. CONTRACTOR SHALL CONSULT AOR FOR FINAL LOCATIONS.
- 17. CONTRACTOR TO PROVIDE AND COORDINATE BLOCKING AS REQUIRED FOR FIXTURES, MILLWORK, EQUIPMENT AND ACCESSORIES. CONTRACTOR TO COORDINATE FINAL LOCATIONS WITH USING AGENCY & AOR.
- 18. PROVIDE FIRESTOPPING AT ALL PIPE AND DUCT SHAFTS LESS THAT 9 SF. PROVIDE 1 HR FIRE RATING IF GREATER THAN 9 SF.
- 19. ALL ITEMS RECESSED INTO ONE OR TWO HOUR FIRE RATED PARTITIONS (SUCH AS OUTLET BOXES, PANEL BOXES, ETC.) SHALL HAVE THE OPENINGS PROTECTED WITH BACK-UP MATERIALS SO AS TO RETAIN THE INTEGRITY OF THE FIRE RATING OF THE PARTITION THROUGHOUT. NO ITEMS SHALL BE RECESSED IN THE EXISTING MASONRY WALLS.
- 20. PATCH AND REPAIR ALL EXISTING AND/OR NEW PARTITIONS THROUGH EXISTING FIRE RATED SLABS AND PARTITIONS, AS REQUIRED, TO MAINTAIN THE EXISTING FIRE RATING PROTECTION.
- 21. PROVIDE NEW INSULATION ON SECTIONS/RUNS OF DUCT AND PIPE WHERE INSULATION WAS PREVIOUSLY DAMAGED.
- 22. SEE MECHANICAL PLANS FOR ADDITIONAL INFORMATION ON SUPPLY DIFFUSERS, RETURN GRILLES, TRANSFER DUCTS, FIRE DAMPERS, DUCTWORK LAYOUTS, ETC. WHERE DISCREPANCIES OCCUR BETWEEN CEILING AND MECHANICAL DRAWINGS, CONTACT AOR FOR RESOLUTION PRIOR TO INSTALLING DEVICES.
- 23. PRIOR TO CLOSING UP THE CEILINGS WHERE INDICATED ON PLANS, CONTRACTOR SHALL TEST ALL ENGINEERING SYSTEMS ABOVE THAT CEILING AND SHALL OBTAIN SIGN OFFS BY THE AGENCIES HAVING JURISDICTION.

## ALTERNATE 1: DRAIN PIPE REROUTING

**ALTERNATES** 

Remove existing drain pipe in Exhibit/Event room. Remove all associated suspension hardware. Infill masonry at interior partition wall in the Exhibit/Event room and exterior wall at the south of the building. Install new drain pipe to redirect drain to the north of the building. Core through the exterior masonry wall for the new pipe and remove a portion of the sidewalk. Provide hardware to secure the vertical drainpipe to the exterior of the masonry wall and install PVC drain pipe to be embedded in the concrete sidewalk. See drawings for additional information.

Base Scope: Existing drain pipe to remain.

#### ALTERNATE 2: REMOVAL OF DROPPED CEILING AT OPEN COLLECTIONS

Remove existing ceiling grid and fixtures over the Open Collections room. Salvage track lighting fixtures, smoke detectors, and ceiling mounted equipment for reinstallation. Mud and tape the existing GWB at the underside of the roof structure, preparing surface to a finished, smooth surface. Prime and paint. Paint also any existing exposed piping and conduit. Likewise, prepare the upper portion of the vertical wall surface that was previously part of the interstitial ceiling space, assume 5' tall area around the perimeter of the room. Install new light fixtures to replace the lay-in 2x4 fixtures and recessed can lighting fixtures. Reinstall track lighting, detectors, and any other misc. ceiling mounted equipment.

Base Scope: Existing dropped ceiling and all fixtures and devices to remain.

#### ALTERNATE 3: NEW MECHANICAL AT GRADE

Locate new mechanical units at grade to the south of the building. This alternate removes all rooftop work and the installation of the new roof hatch in the mechanical room. Power location to the air handling unit is relocated from the roof to grade. Gas piping is rerouted to the unit. Duct routing is also adjusted per the alternate location. Provide concrete pad for unit at grade. Refer to mechanical drawings for additional scope notes on this alternate.

Base Scope: New mechanical units located atop the roof as shown on plans with ducts and new gas piping routed per mechanical plans.

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REVISION

NO.	DATE	REMARKS

#### **GENERAL ACCESSIBILITY NOTES**

- 1. Project is required to comply fully with the following regulations:
- 1.1. ICC/ANSI A1117.1-2018 Illinois Accessibility Code
- 2. All controls and operating mechanisms to be within reach range per ICC/ANSI A1117.1-2003 Chapter 3.308 and 3.309, (ie: 15" to 48" AFF)
- 3. Provide proper maneuvering clearance at door per ICC/ANSI A1117.1-2003 Chapter 4.404.2.3.
- 4. All doors must have a 32" clear door opening measured from the face of the door when it is opened 90% to the door stop per ICC/ANSI A1117.1-2003 Chapter 4.404
- 5. All doors leading into hazardous rooms or spaces to have knurled hardware per CBC Chapter 18-11-1109.9.5. All public and common area interior doors to have 5# max. force to open per IAC 400.310 (1-10)
- 6. All public and common area exterior doors to have 8.5# max. force to open perIAC400.31 0(1-10)
- 7. Forward/front approach and side parallel approach reach range for all controls and operating mechanism to be 15" to 48" per ICC/ANSI A1117.1-2003 Chapter
- 8. Floor surfaces shall be firm stable and slip resistant per ICC/ANSI A1117.1-2003 Section 302.1.
- 9. All new, altered, relocated or replaced fire alarm or emergency warning system to comply fully with ICC/ANSI A1117.1-2003 section 7.702. All visual alarms to be synchronized throughout. Per ICC/ANSI A1117.1-2003 Chapter 702.

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SHEET INDEX, GENERAL NOTES ABBREVIATIONS

PROJECT NUMBER: 2206-01

DATE: 01/27/2023

DRAWN BY: AS

CHECKED BY: HZ

SCALE: PER DWG

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#### ARCHITECTURAL SPECIFICATIONS

#### 01045 CUTTING AND PATCHING

A. When making alterations to existing construction use materials for cutting and patching that match existing adjacent surfaces to the fullest extent possible with regard to visual effect. Use material that will result in equal-or-better performance characteristics. Restore exposed finishes of patched areas and where necessary extend finish restoration into retained adjoining work in a manner which will eliminate evidence of patching and refinishing.

#### 01590 CLEAN-UP

A. Clean-Up and Debris Removal: The General Contractor shall coordinate the removal of debris with the Subcontractors and the Building Management. Premises are to be swept clean on a daily basis. General Contractors shall coordinate with Building Management regarding any Covid-related cleaning procedures.

#### 02080 REMOVAL

- A. The General Contractor shall coordinate the removal with the Sub-Contractors.
- B. Before beginning the removal, check the drawings for items that are to be reused and check with the Owner for items the Owner wishes to reserve for their own salvage. C. Whenever possible reuse existing items such as doors, frames, hardware, lights, exit signs, diffusers, that meet the project specifications.
- C. In the areas of new construction, remove the walls, ceilings, floor finishes, etc. Contractors shall determine what shall be removed and what shall be retained for future use.
- D. Contractor is responsible for complying with all applicable codes and requirements for recycling and waste removal.

#### 03540 CEMENTITIOUS SELF-LEVELING OVERLAY FLOOR

- A. Applicator Qualifications: Company specializing in performing the work of this section, and approved by manufacturer.
- B. Store products in manufacturer's unopened packaging until ready for installation.C. Keep dry and protect from direct sun exposure, freezing, and ambient temperature
- greater than 105 degrees F.

  D. Do not install overlay until floor penetrations and peripheral work are complete.
- E. Comply with manufacturer's written recommendations for substrate temperature and moisture content, ambient temperature and humidity, ventilation, and other conditions affecting overlay performance.
- F. Close areas to traffic during overlay application and for time period after application recommended by manufacturer.
- G. During the curing process, ventilate spaces to remove excess moisture.
- H. Cementitious Overlay: Flowable, Blended cement-based, polymer-modified cementitious topping, that when mixed with water in accordance with manufacturer's directions will produce self-leveling overlayment with the following properties:
  - a. Cement: Portland cement per ASTM C150/C150M; or hydraulic or blended hydraulic cement per ASTM C219.
  - b. Compressive Strength: Minimum 4000 pounds per square inch after 28 days, tested per ASTM C109/C109M.
  - c. Flexural Strength: Minimum 1000 psi after 28 days, tested per ASTM C348.
  - d. Density: 125 pounds per cubic foot, nominal.
  - e. Final Set Time: 1-1/2 to 2 hours, maximum.
  - f. Thickness: Capable of thicknesses from feather edge to maximum 3-1/2 inch.
  - g. Surface Burning Characteristics: Flame spread/Smoke developed index of 0/0 in accordance with ASTM E84.
  - h. Aggregate: Dry, well graded, washed silica aggregate, approximately 1/8 inch in size and acceptable to overlay manufacturer.
  - Reinforcement: Galvanized metal lath complying with recommendations of overlay manufacturer for specific project circumstances.
  - j. Water: Potable and not detrimental to overlay mix materials.
  - k. Primer: Manufacturer's recommended type.

I. Joint and Crack Filler: Latex based filler, as recommended by manufacturer. I. Prior to installation, verify that substrate surfaces are clean, dry, unfrozen, do not contain compounds detrimental to overlay material bond to substrate. Prepare existing concrete surfaces according to ICRI 310.2R. Remove substrate surface irregularities. Fill voids and deck joints with filler. Finish smooth. Vacuum clean surfaces. Provide clean, dry, neutral-pH substrate for underlayment application. Prime substrate in accordance with manufacturer's instructions and allow to dry.

J.Close floor openings. Fill all voids with self-compacting fill. Treat nonmoving substrate cracks to prevent cracks from telegraphing through overlay according to manufacturer's written recommendations. After substrate preparation, test substrate for adhesion with overlay according to manufacturer's instructions.

K. Install overlay in accordance with manufacturer's instructions. Protect against direct sunlight, heat, and wind; prevent rapid drying to avoid shrinkage and cracking. Do not permit traffic over unprotected floor overlay. Protect from concentrated and rolling loads for remainder of construction period.

#### 05120 STRUCTURAL STEEL FRAMING

- A. The steel sizes and configurations indicated on the structural drawings are conjectural. All bearing conditions and resulting spans must be field verified.
- B. The steel support structure must be analyzed and designed by a structural engineer licensed to practice in the State of Illinois.

#### 07015 ROOF PATCHING

- A. Patch existing roof wherever affected by new construction as required to maintain the system weathertight and existing warranty (if any) in full force and effect.
- B. Installer Qualifications: Company experienced in performing the type of work required in this section with minimum three years documented experience, and approved by manufacturer.
- C. Install work only under environmental conditions recommended by the flashing material's manufacturer.
- D. Investigate the existing roof system to determine the type of existing roofing systems to be cut and patched. For roofs under guarantee, investigate with the roofing system producer's authorized technical representative. For single ply roofs not under guarantee, investigate with a qualified technical party skilled and knowledgeable in the types of roof membranes to be cut and patched.
  - a. For roofs under warranty, use materials and techniques required to maintain existing warranty in effect. For out of warranty single ply roofs, utilize insulation and roof membrane/flashing system matching existing or as otherwise appropriate.
- E. Preparation: Cut back insulation and roof membrane to straight line.
- F. Installation: Cut insulation to exactly fill void to top of existing roof membrane and install in roofing cement. Provide cants and insulate curbs as required to provide sound, level substrate for flashing. Prime contact surface, as recommended by system manufacturer.
- G. Roofs in Warranty: Install roofing system required to maintain guarantee in full force and effect.
- H. Out of Warranty/Guaranty Single Ply Roofs: Install roofing/flashing system established to be appropriate as required to maintain roof watertight.

#### 07720 ROOF ACCESSORIES

- A. Access hatch and ladder.
  - a. Install in accordance with manufacturer's instructions, in manner that maintains roofing system weather-tight integrity.
  - b. Reference Standard: 29 CFR 1910.23 Ladders current edition.
  - c. Roof Hatches: Factory-assembled aluminum frame and cover, complete with operating and release hardware.
    - 1. Style: Provide flat metal covers unless otherwise indicated.
    - 2. Mounting: Provide frames and curbs suitable for mounting conditions as indicated on drawings.
    - 3. Thermally Broken Hatches: Provide insulation within frame and cover.
    - 4. Size: Single leaf; 36 by 30 inches.
  - d. Safety Post: Provide telescoping safety post designed to serve as a handrail extending above the top rung of the hatch ladder.
  - e. Hardware: Steel, zinc coated and chromate sealed, unless otherwise indicated or required by manufacturer.
  - f. Lifting Mechanisms: Compression or torsion spring operator with shock absorbers that automatically opens upon release of latch; capable of lifting covers despite 10 psf load
  - g. Hinges: Heavy duty pintle type. Hold open arm with vinyl-coated handle for manual
  - h. Latch: Upon closing, engage latch automatically and reset manual release.
  - i. Manual Release: Pull handle on interior.
  - j. Locking: Padlock hasp on interior.

#### 08100 ROUGH CARPENTRY

- A. Lumber for Miscellaneous Uses: Unless otherwise indicated, provide standard grade lumber for support of other work, including grounds, bucks, nailers, blocking, furring, grounds, stripping and similar members.
- B. Plywood Backing for Electrical and Telephone Equipment: APA C-D PLUGGED INT with exterior glue, fire-retardant treated, ½" thick except as otherwise indicated.
- C. Fasteners and Anchorages: Of size, type, material and finish suited to application shown. Provide metal hanger and framing anchors of size ant type recommended for intended use by manufacturer.
- D. Fire-Retardant Treated Wood: Where wood is indicated for fire-retardant treatment comply with AWPA C20 and AWPA C27 (plywood) for treatment. Provide label from an approved agency. Redry treated lumber.
- E. Securely attach carpentry work to substrates and supporting members using fasteners of size that will not penetrate members where opposite side will be exposed to view or receive finish materials. Install fasteners without splitting wood; fasten panel products to allow for expansion at joints unless otherwise indicated.

#### 09250 GYPSUM DRYWALL

- A. General Standard: GA-216 by Gypsum Association, or manufacturer's instructions (whichever is more stringent).
- B. Metal Support Standard: ASTM C 754 and ASTM C 645
- C. Gypsum Board Standard: ASTM C 1840 and ASTM C 36
- D. Gypsum Backing Board for Multi-layer Applications: ASTM C 442 or A 36
- E. Trim Accessories: Provide Mfr's. standard metal trim accessories, of the beaded type with face flanges for concealment in joint compound. Provide comer beads, L-type edge trim beads, LI-type beads, special L-kerf-type edge trim-beads, and one piece control beads.
- F. Gypsum Board Fasteners: Type recommended by gypsum board mfg., except as otherwise indicated.
- G. Joint Tape: ASTM c 475, paper reinforcing tape.
- H. Joint Compound: ASTM C 476
- I. Installation of Metal Support Systems: Do not bridge building expansions joints with support systems, frame both sides of joints with furring and other supports as indicated.
- J. Wall/ Partition Support System:
- a. Install steel studs with bottom and top runner tracks anchored to substrates. Isolate system from building structure to prevent transfer of loading and deflections into metal support system, both vertically and horizontally.
- b. Frame door and other openings with studs and runners. Gauge, number and arrangement of studs to comply with manufacturer's recommendations for size of opening, weight and height of doors and stud size, unless otherwise indicated
- c. Install supplementary framing, runners, furring, blocking and bracing at openings end termination in gypsum drywall and where required for support of the work which cannot be adequately supported on gypsum board alone.
- O. Drywall Installation and Finishing:
- a. Install gypsum boards in lengths and directions which will minimize number of joints. Install walls and partitions with exposed gypsum boards vertical, joints offset on opposite sides of partitions.
- b. Form control joints with 1/2" space between boards.
- c. Install acoustical sealant at base of space, and apply trim accessory at face.
- d. Acoustical Sealant: Where work is indicated as "Sound Retarding" or shown with an STC rating, apply acoustical sealant as recommended by manufacturer.
- e. Isolate drywall work from abutting structural and masonry work; provide edge trim and acoustical sealant as recommended by manufacturer.
- f. Screw gypsum board to metal supports.
- g. Screw both layers to supports where double-layer work is indicated or otherwise required.
- h. Do not bridge building expansion joints. Leave space of the width indicated between boards, and trim both edges for installation of sealant or gasket.
- P. Drywall Finishing: Except as otherwise indicated, apply joint tape and joint compound at joints (both directions) between gypsum boards. Install compound in three coat where recommended by mfr. and apply compound at accessory flanges, penetrations, fasteners, heads and surface defect after last two coats.

#### 09655 RESILIENT BASE

- A. Vinyl Wall Base: FS SS-W-40 Type II
- B. Install resilient base in accordance with the manufacturer's instructions. Secure base to surfaces with waterproof cement; make joints light; keep top and bottom edges in firm contact with adjacent surfaces. Use longest lengths possible; straight pieces less than 23" long are not permitted. Miter or cope inside comers and use premolded outside corner.

#### 09900 PAINTING

- A. Description of work: Painting and finishing of interior wall surfaces where indicated on plans and where wall finishes have been affected by construction work. Three coat finishes shall be provided in low odor, low VOC paints. Walls shall be final coat eggshell 15-20 units @85°. All hollow metal shall be final coat semi-gloss 45-55 units @60°.
- B. Coordination: Provide finish coats which are compatible with prime paints used. Provide barrier coats over incompatible primers where required. Notify Architect in writing of anticipated problems using specified coatings wilt! substrates primed by others.
- C. Application: Apply painting and finishing materials in accordance with manufacturer's directions. Use applicators and techniques best suited for materials and surfaces to which applied.
- a. Omit first coat (primer) on metal surfaces which have been shop-primed and touch-up painted, unless otherwise specified.
- b. Apply prime coat to material which is required to be painted or finished, and which has not been prime coated by others.
- c. Apply each material at not less than manufacturer's recommended spreading rate.

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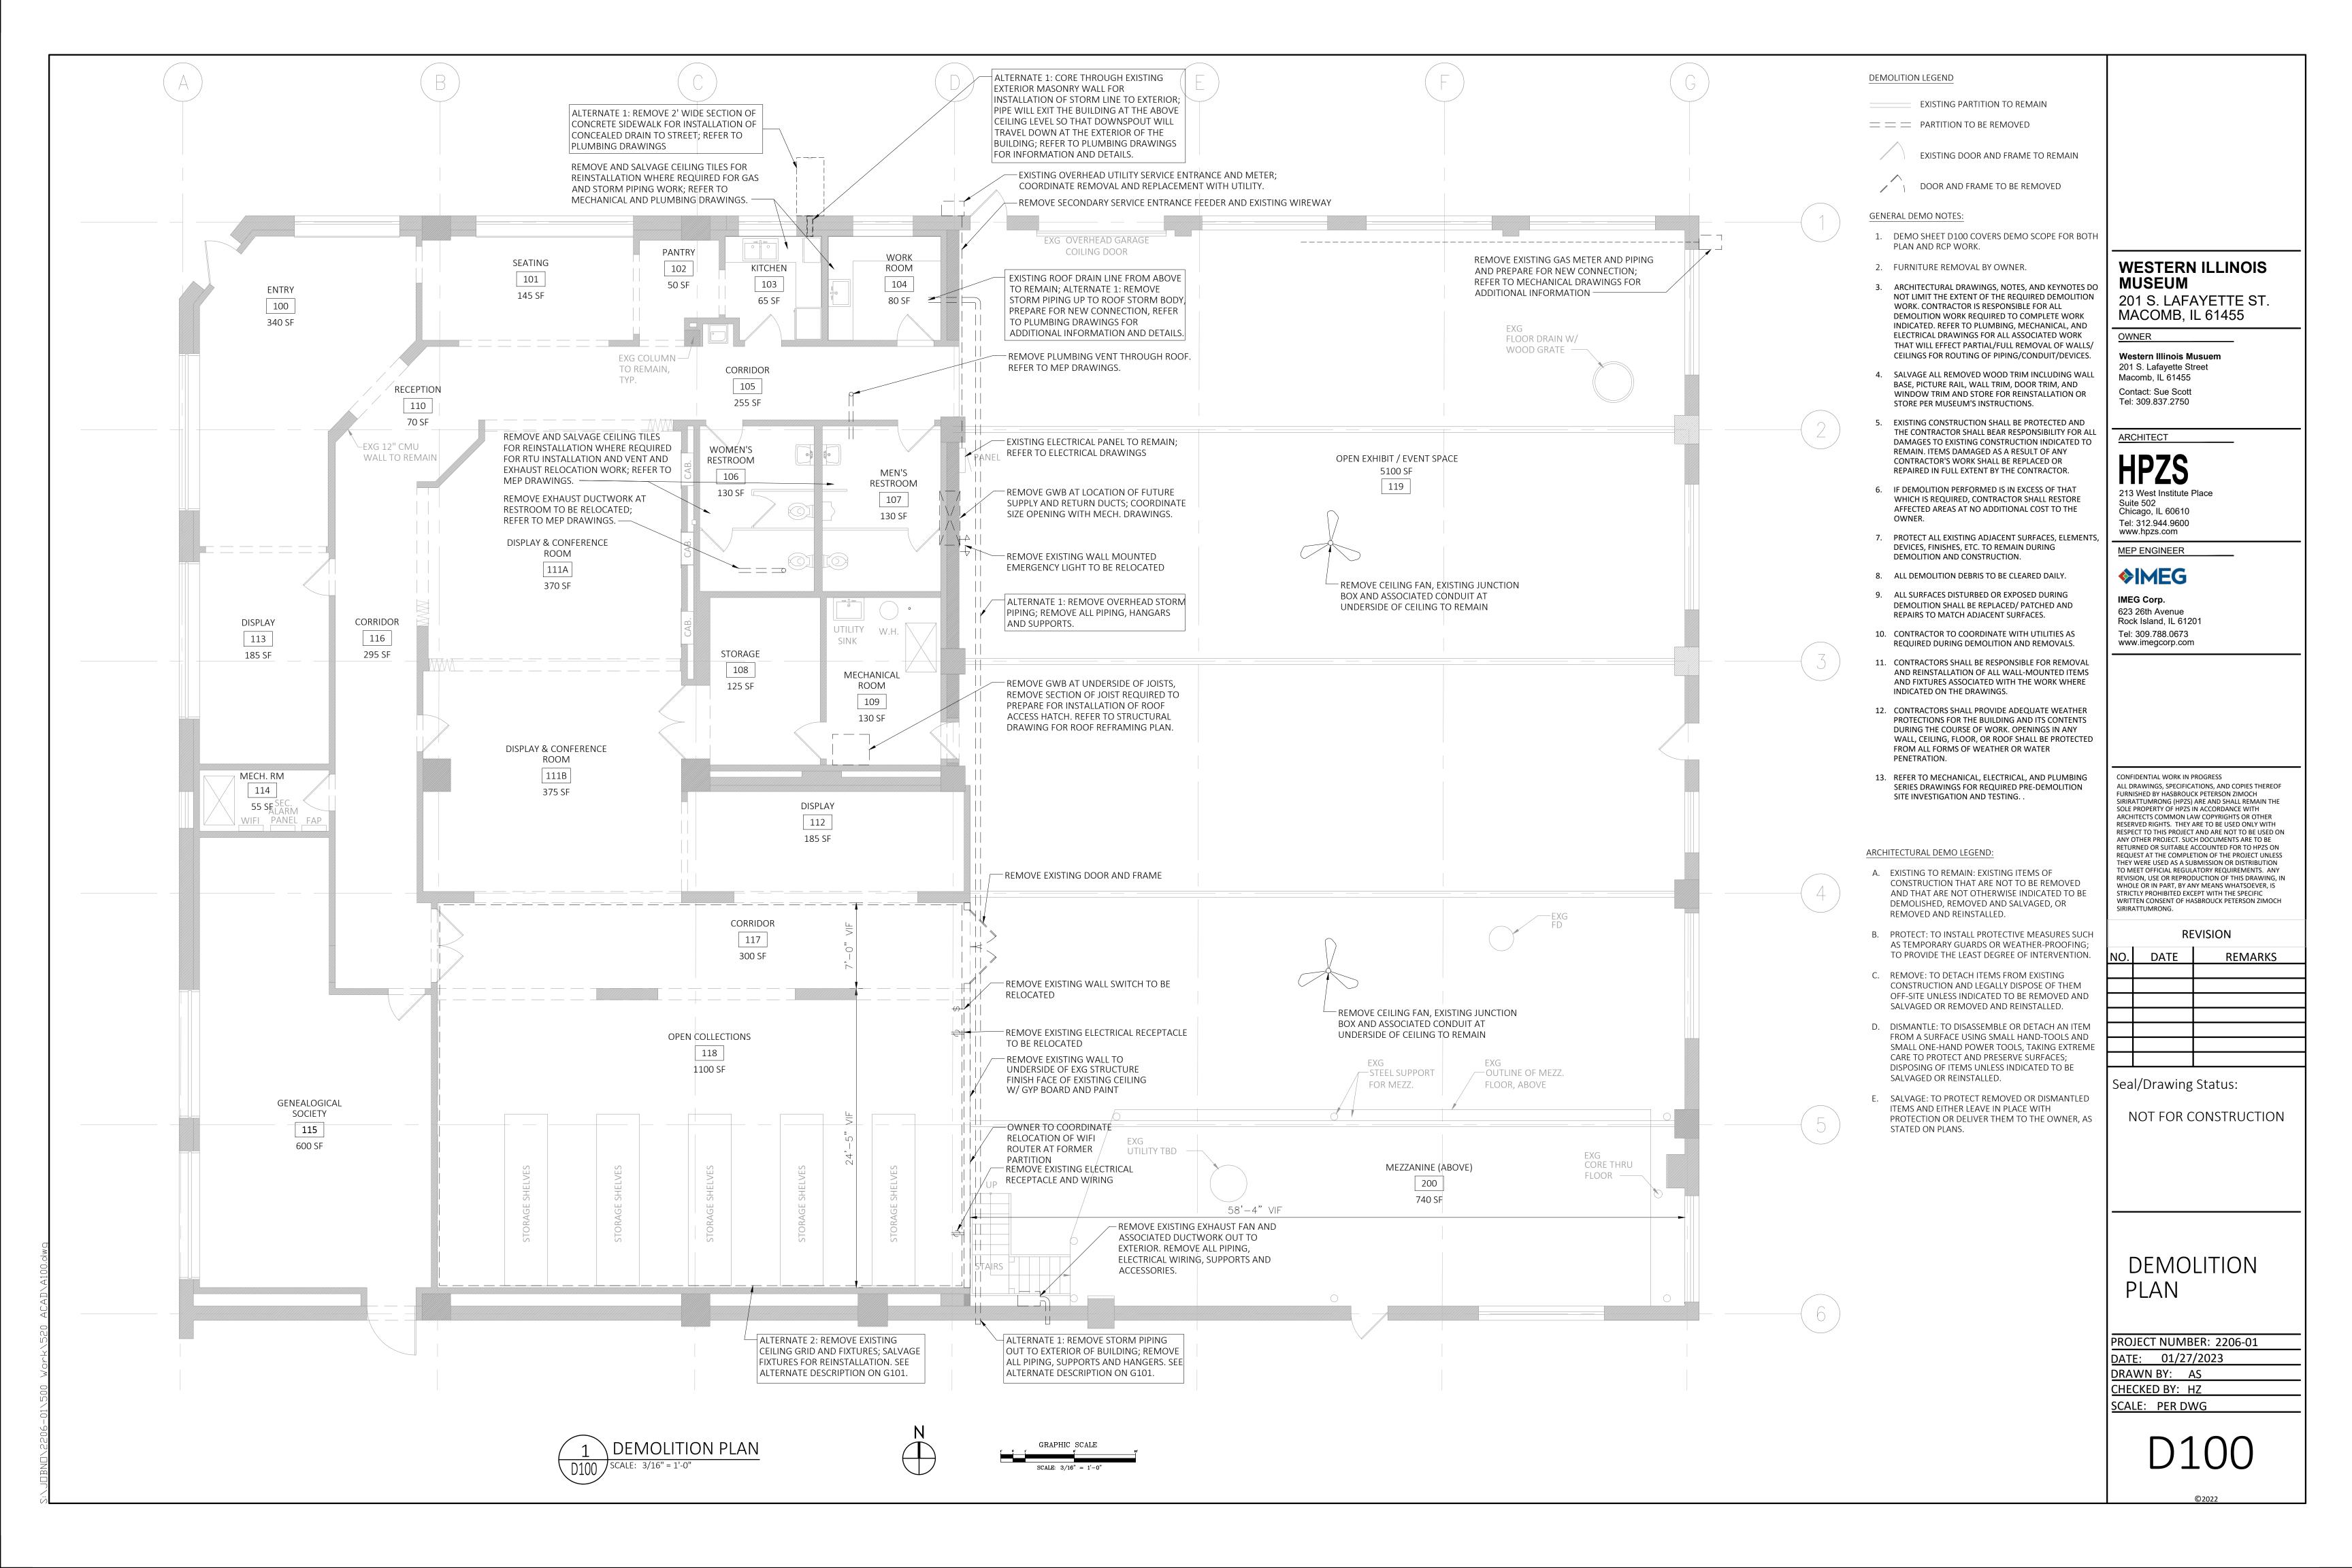
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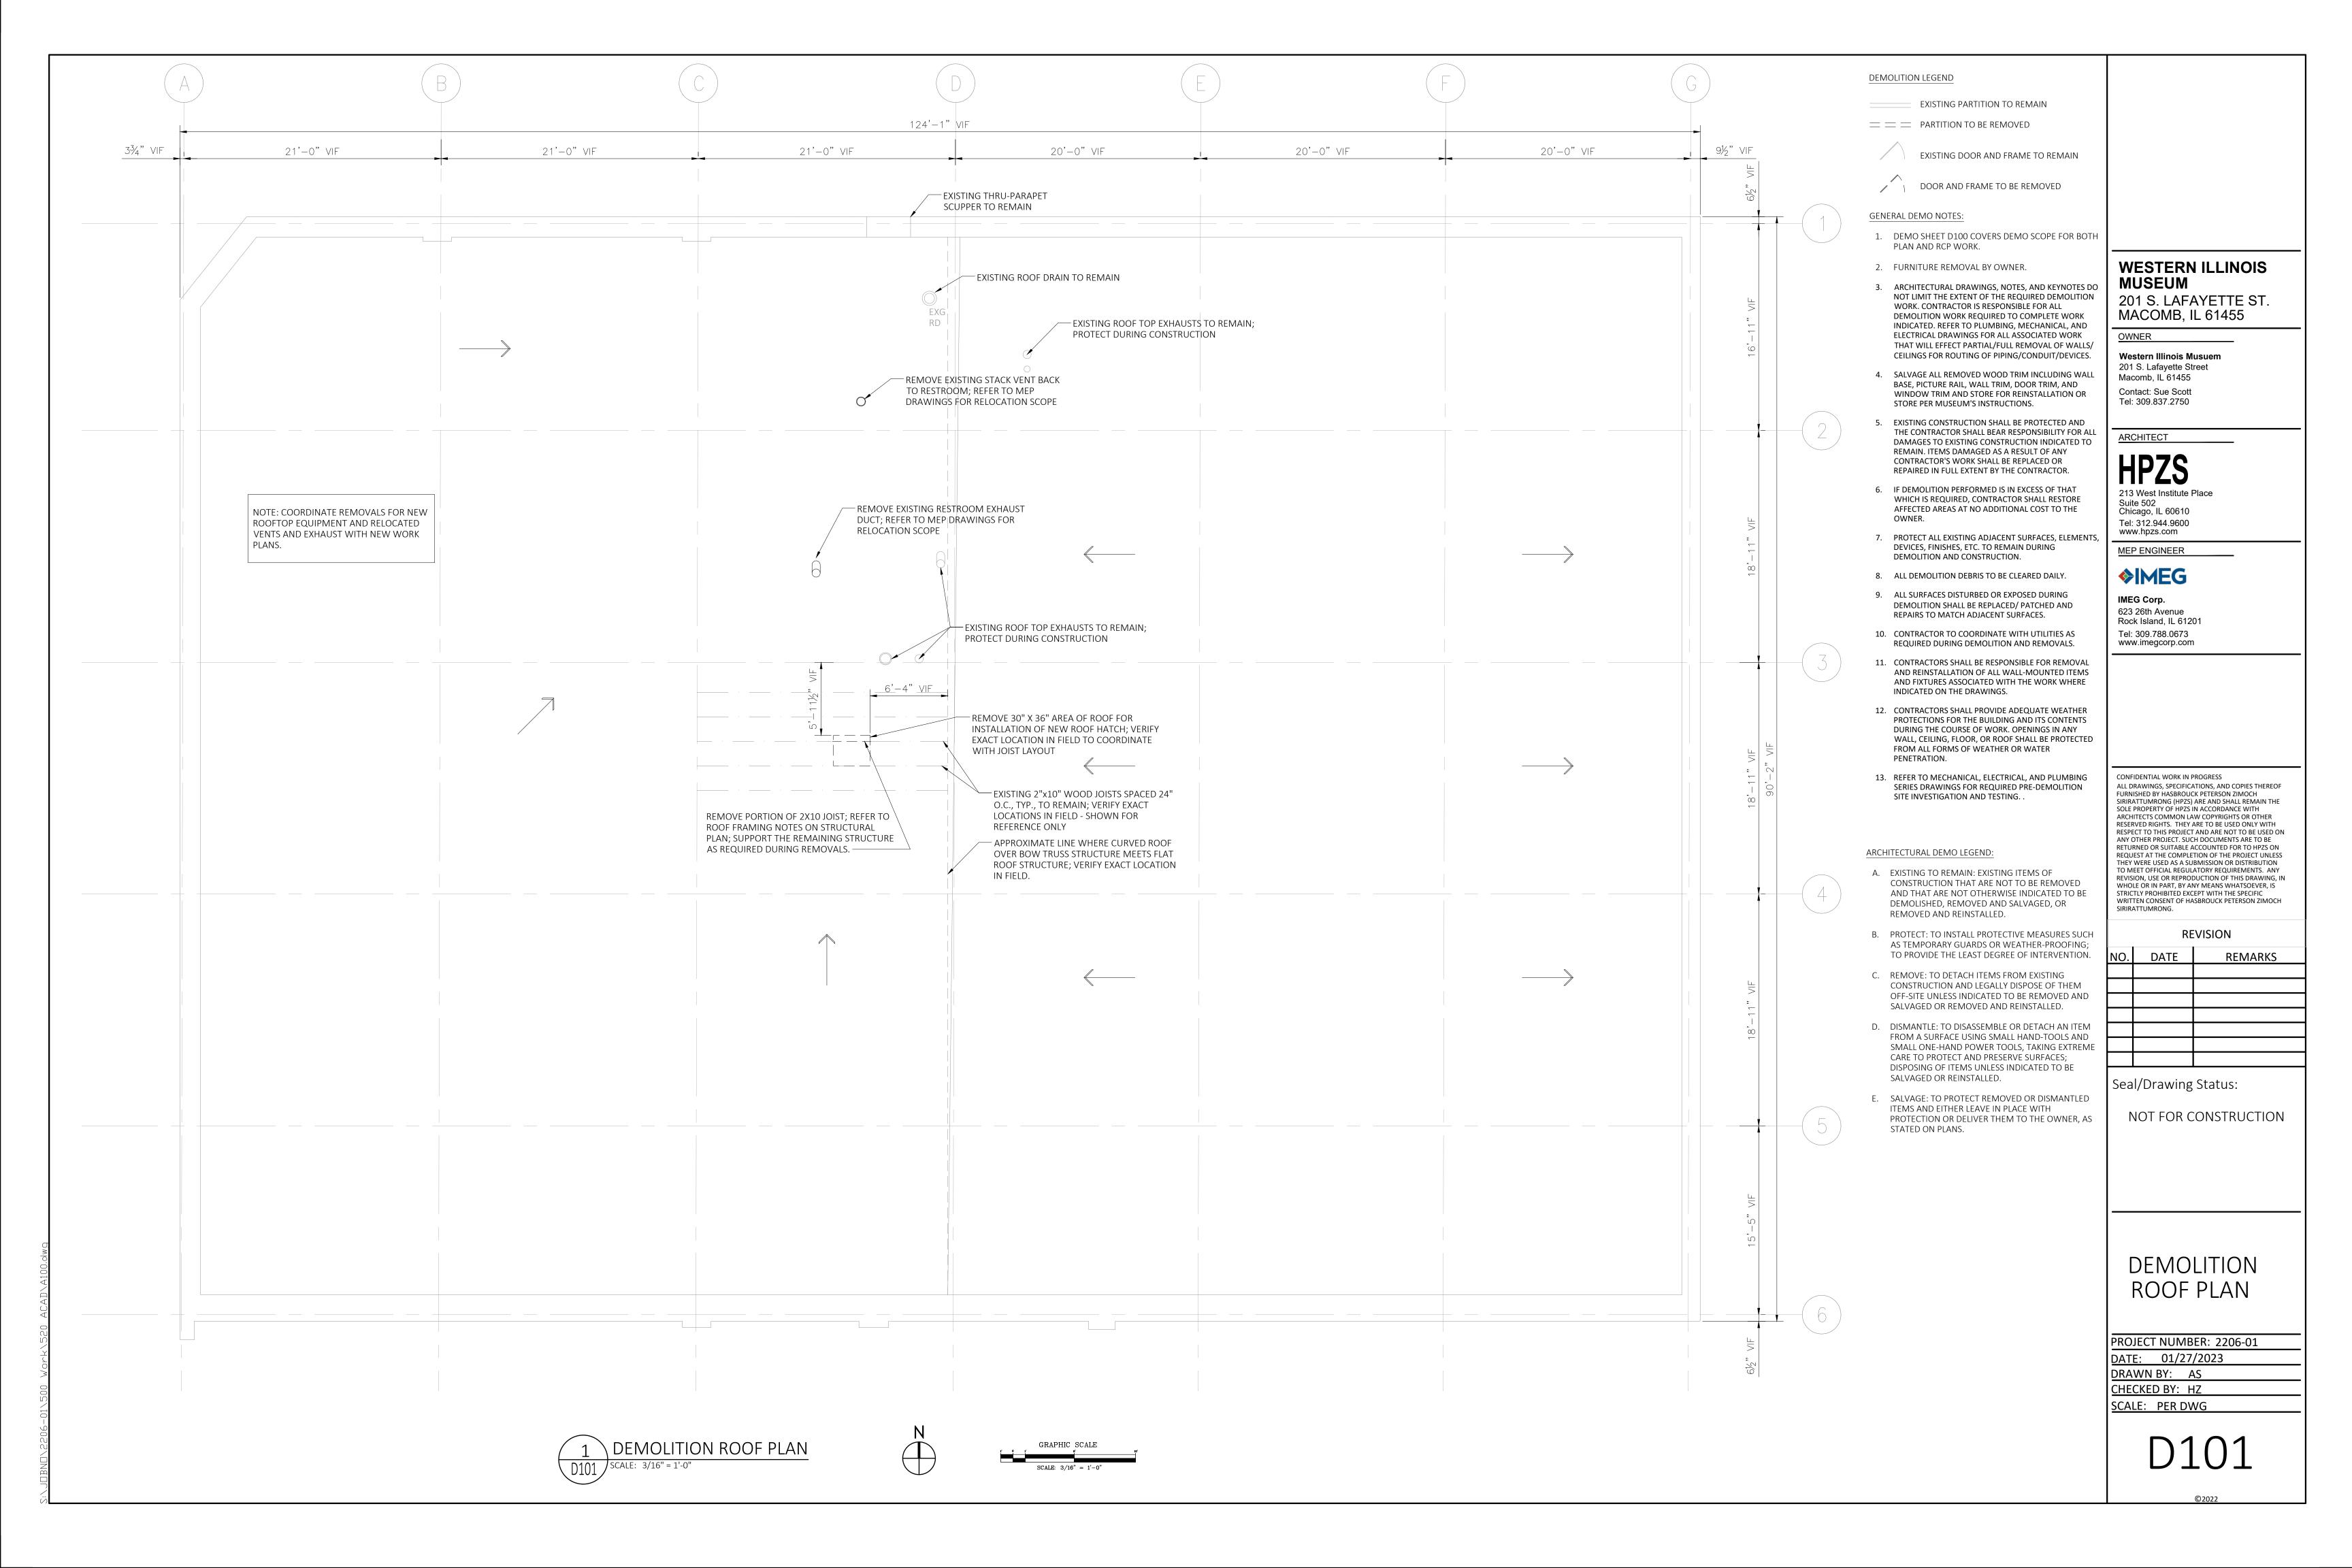
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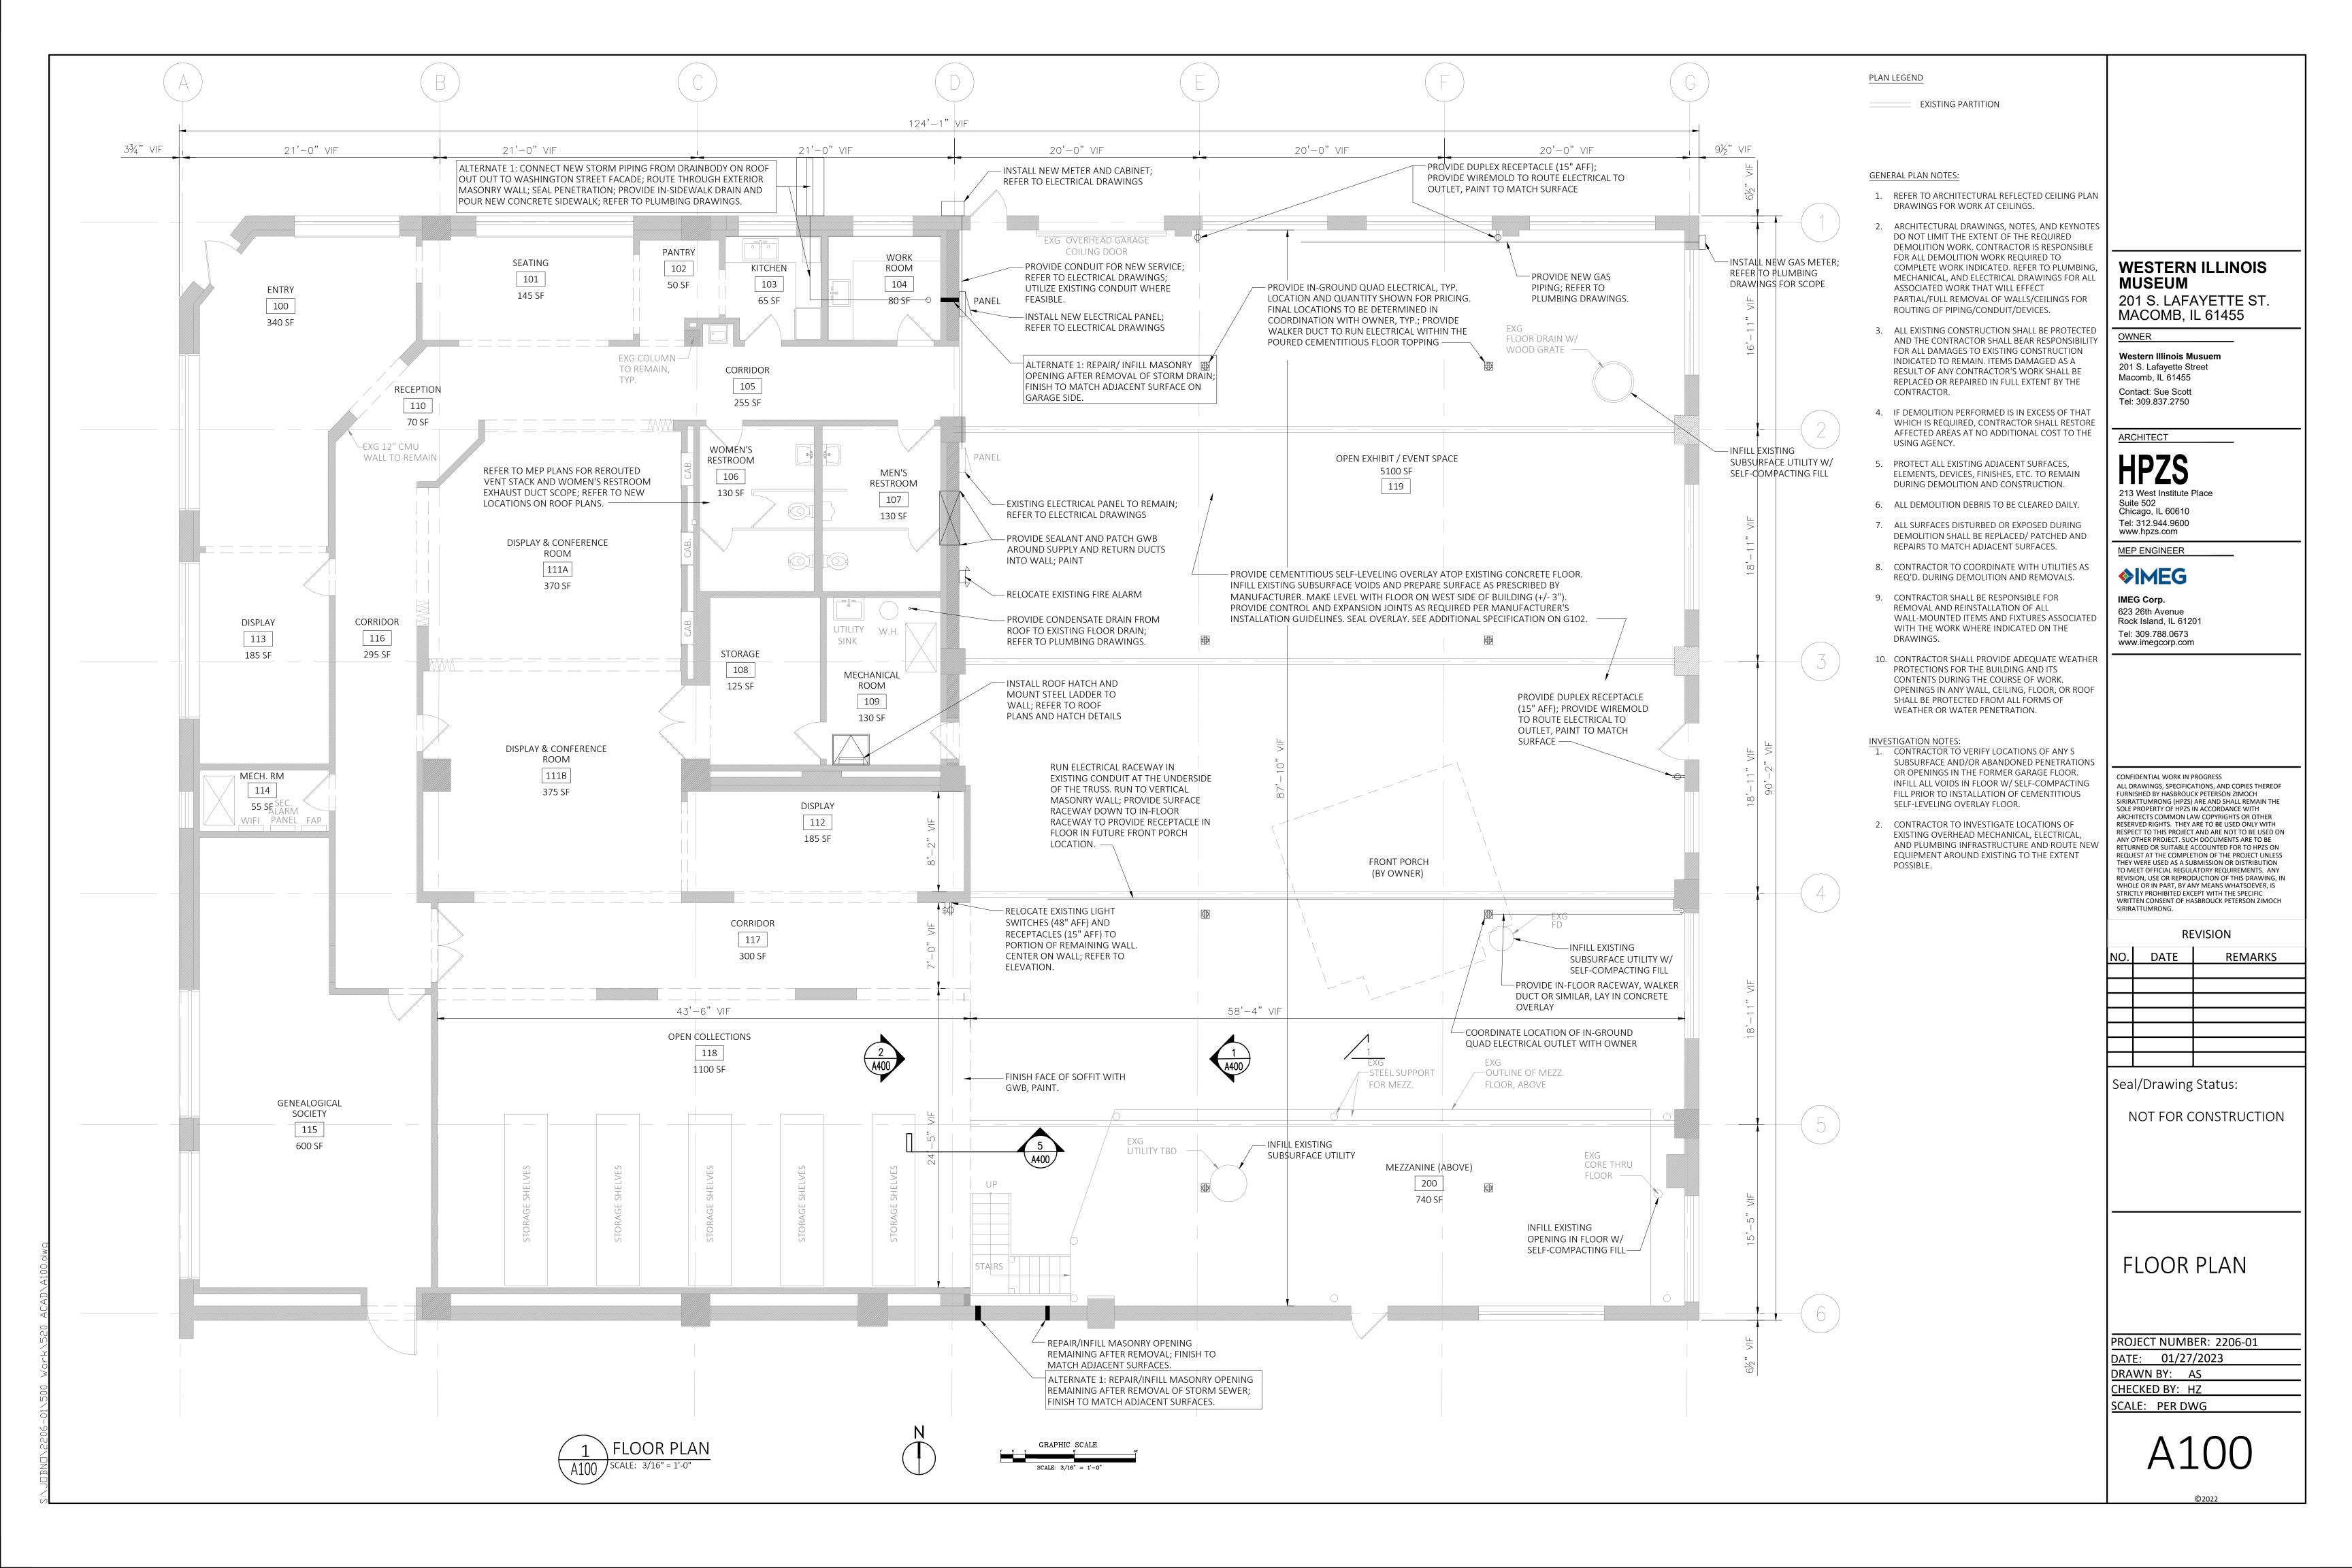
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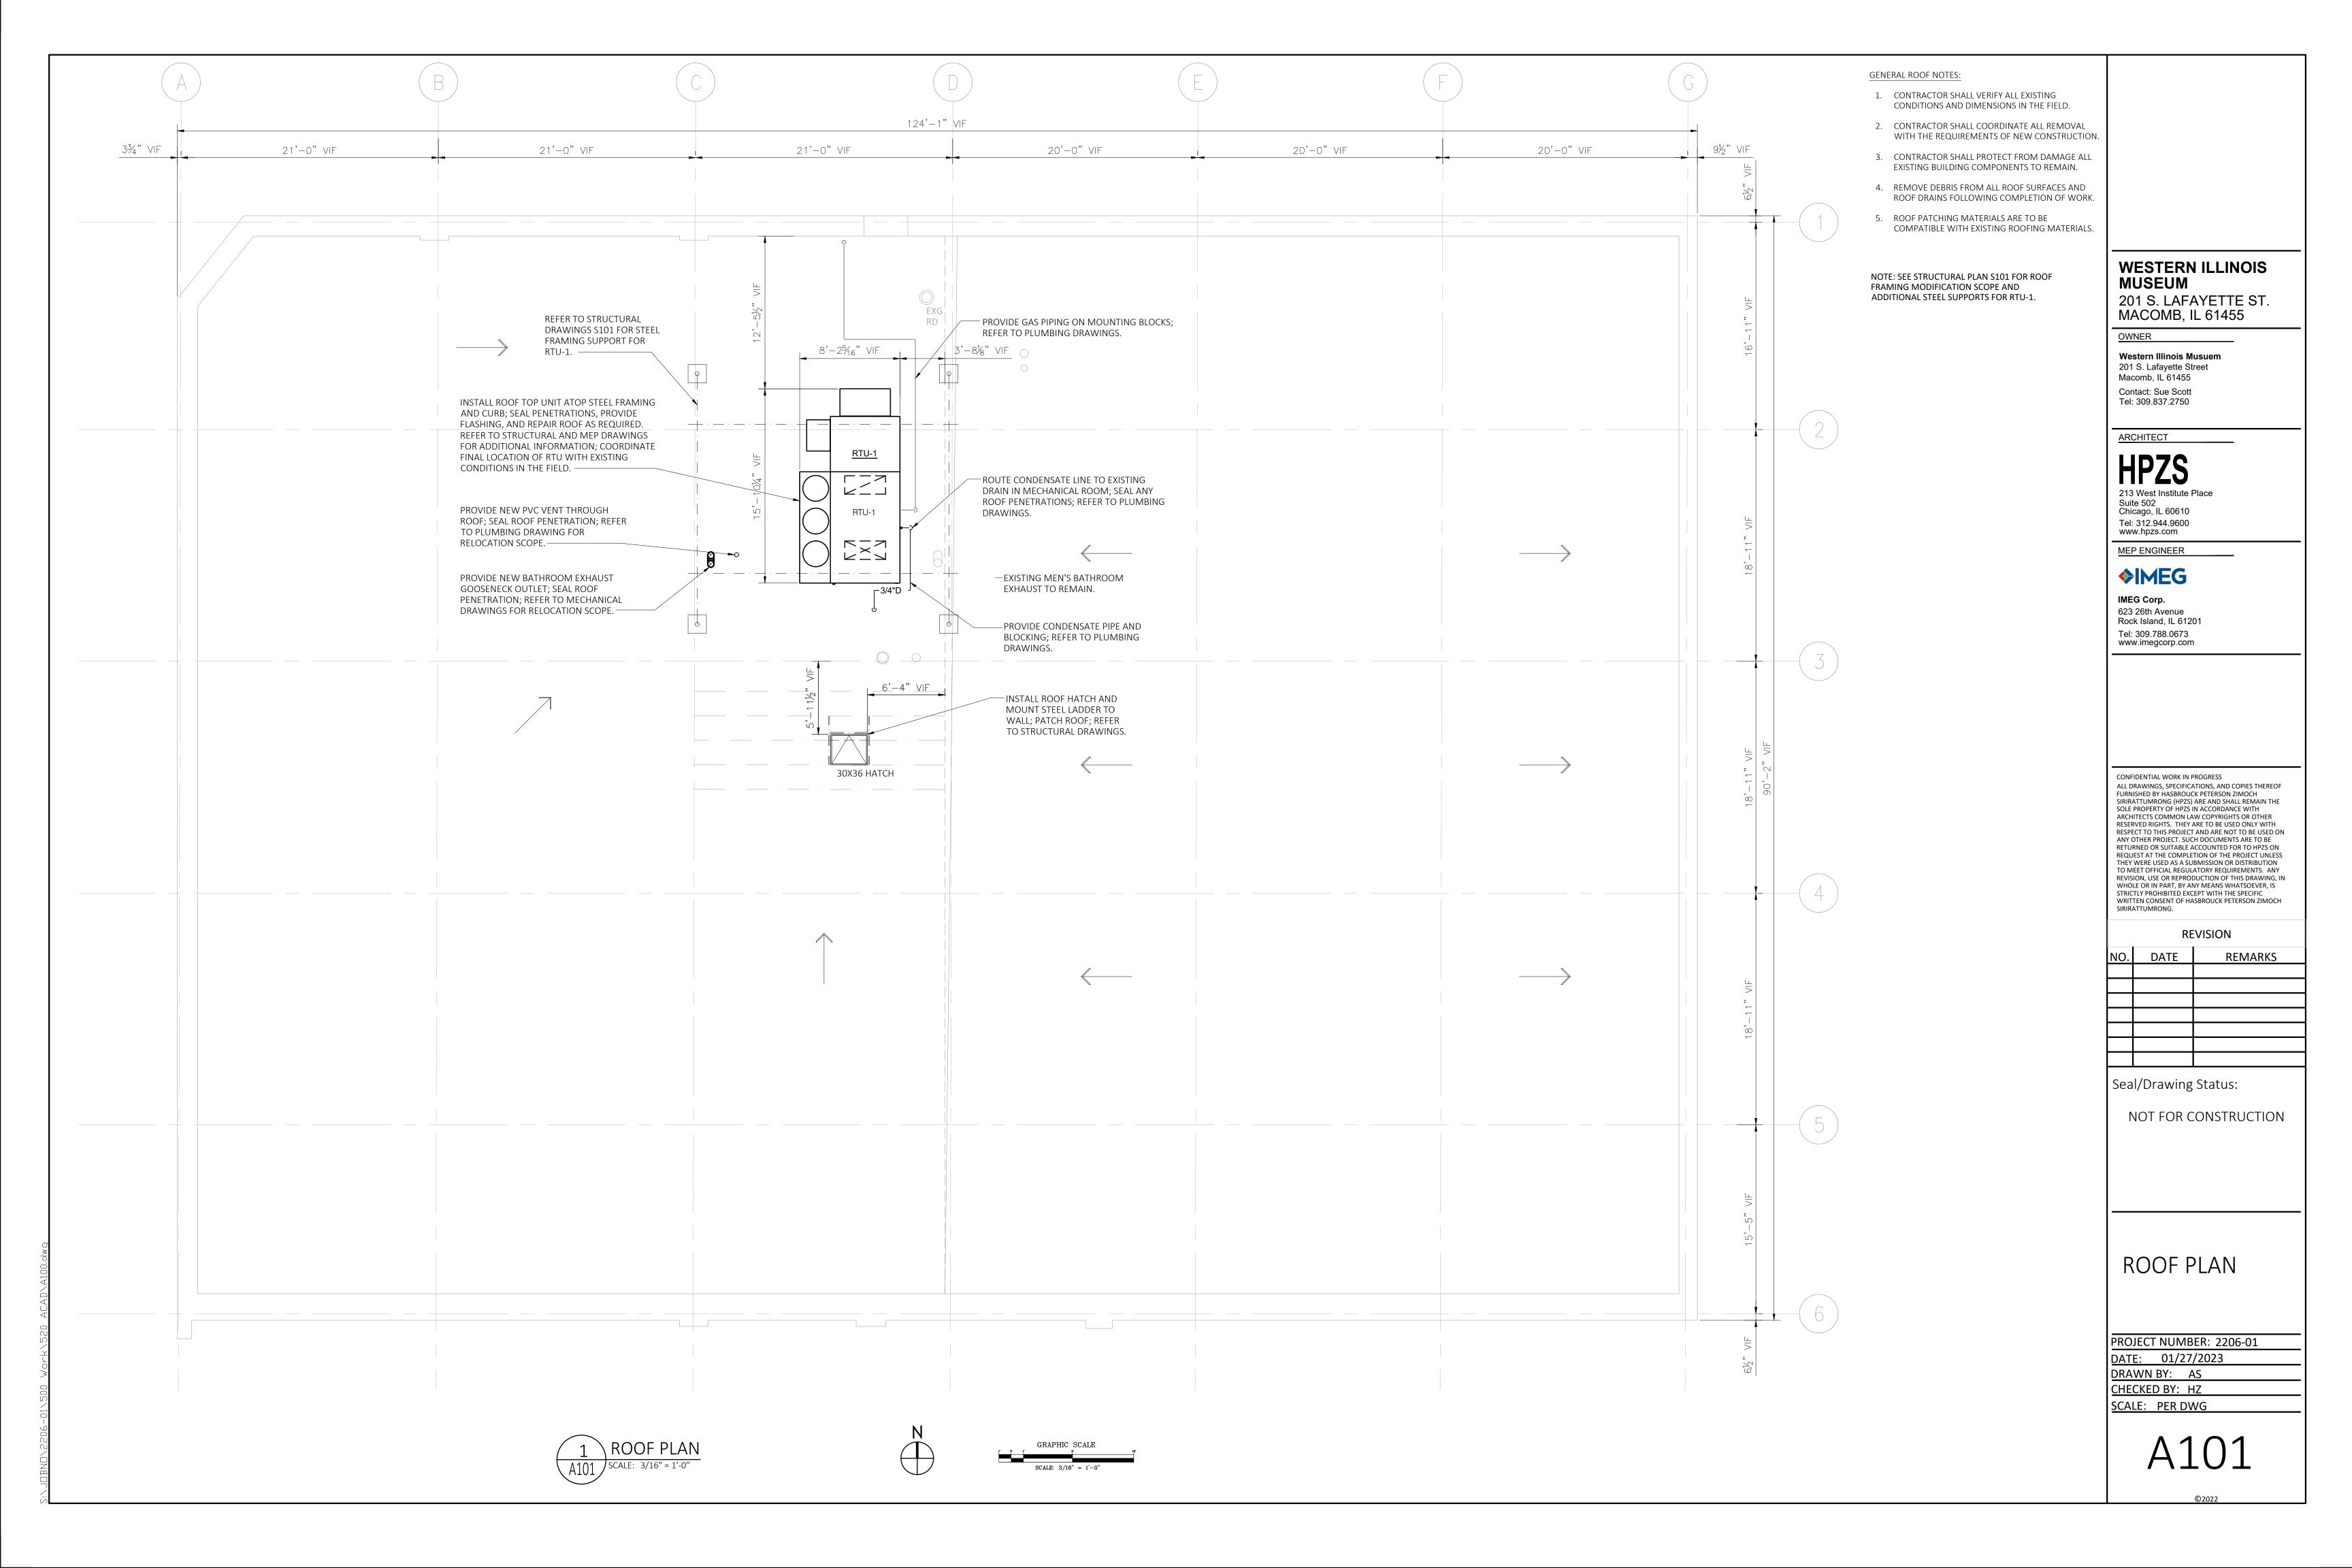
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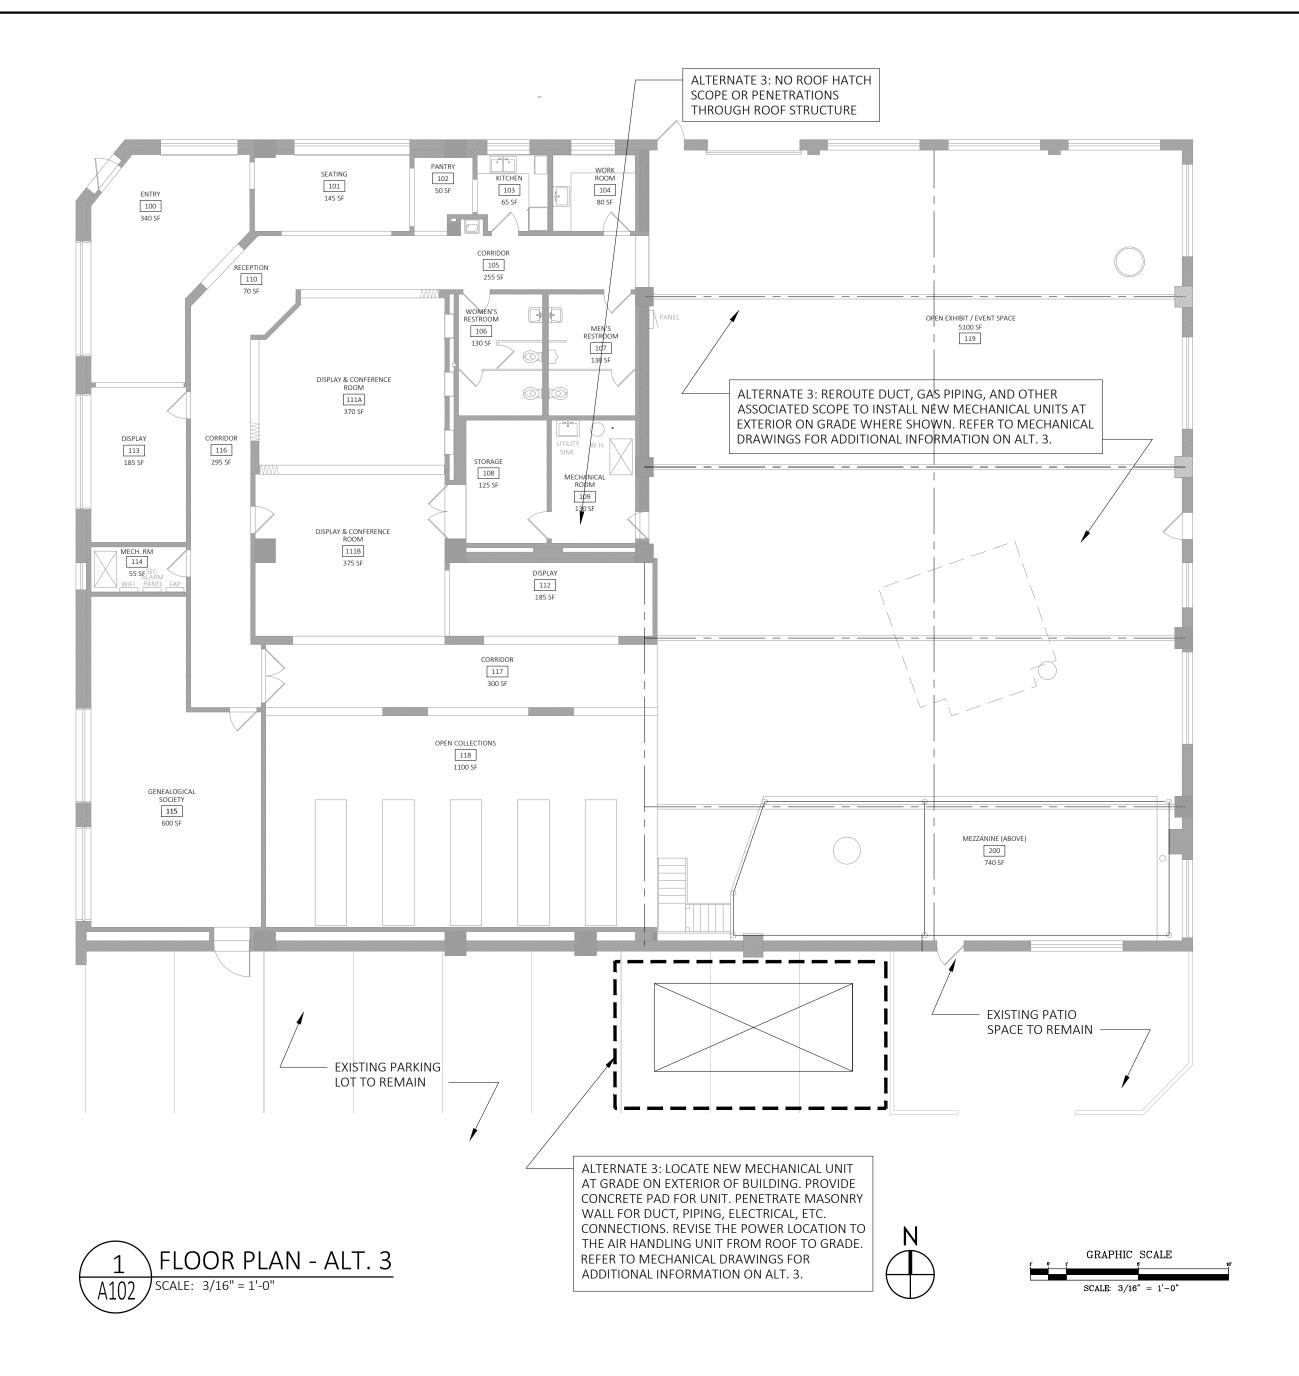
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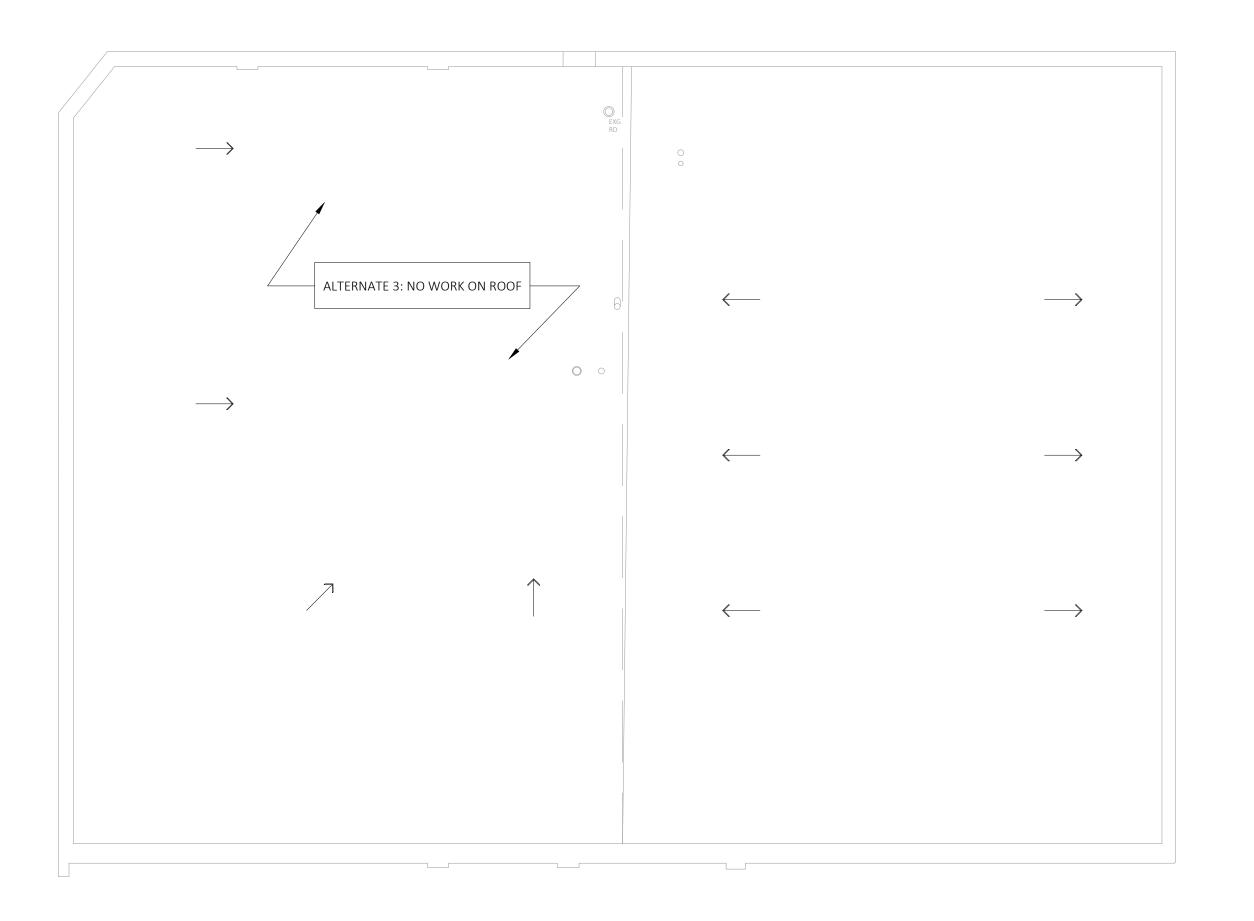












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GRAPHIC SCALE



ALTERNATE 3: UTILIZE EXISTING PARKING LOT SPACE ON THE SOUTH SIDE OF THE BUILDING TO PLACE NEW MECHANICAL UNITS. REFER TO MECHANICAL DRAWINGS FOR ADDITIONAL INFORMATION ON ALT. 3.

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ALTERNATE 3 PLANS


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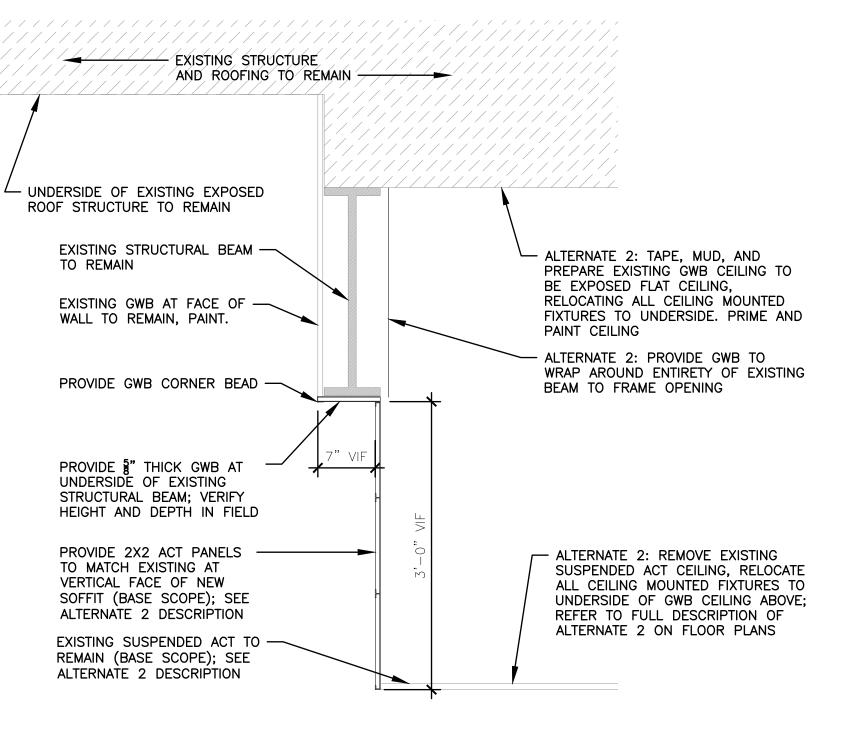
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CHECKED BY: HZ

SCALE: PER DWG

A102


3 SOUTH ELEVATION PHOTO REFERENCE - ALT. 3
A102 SCALE: 3/16" = 1'-0"



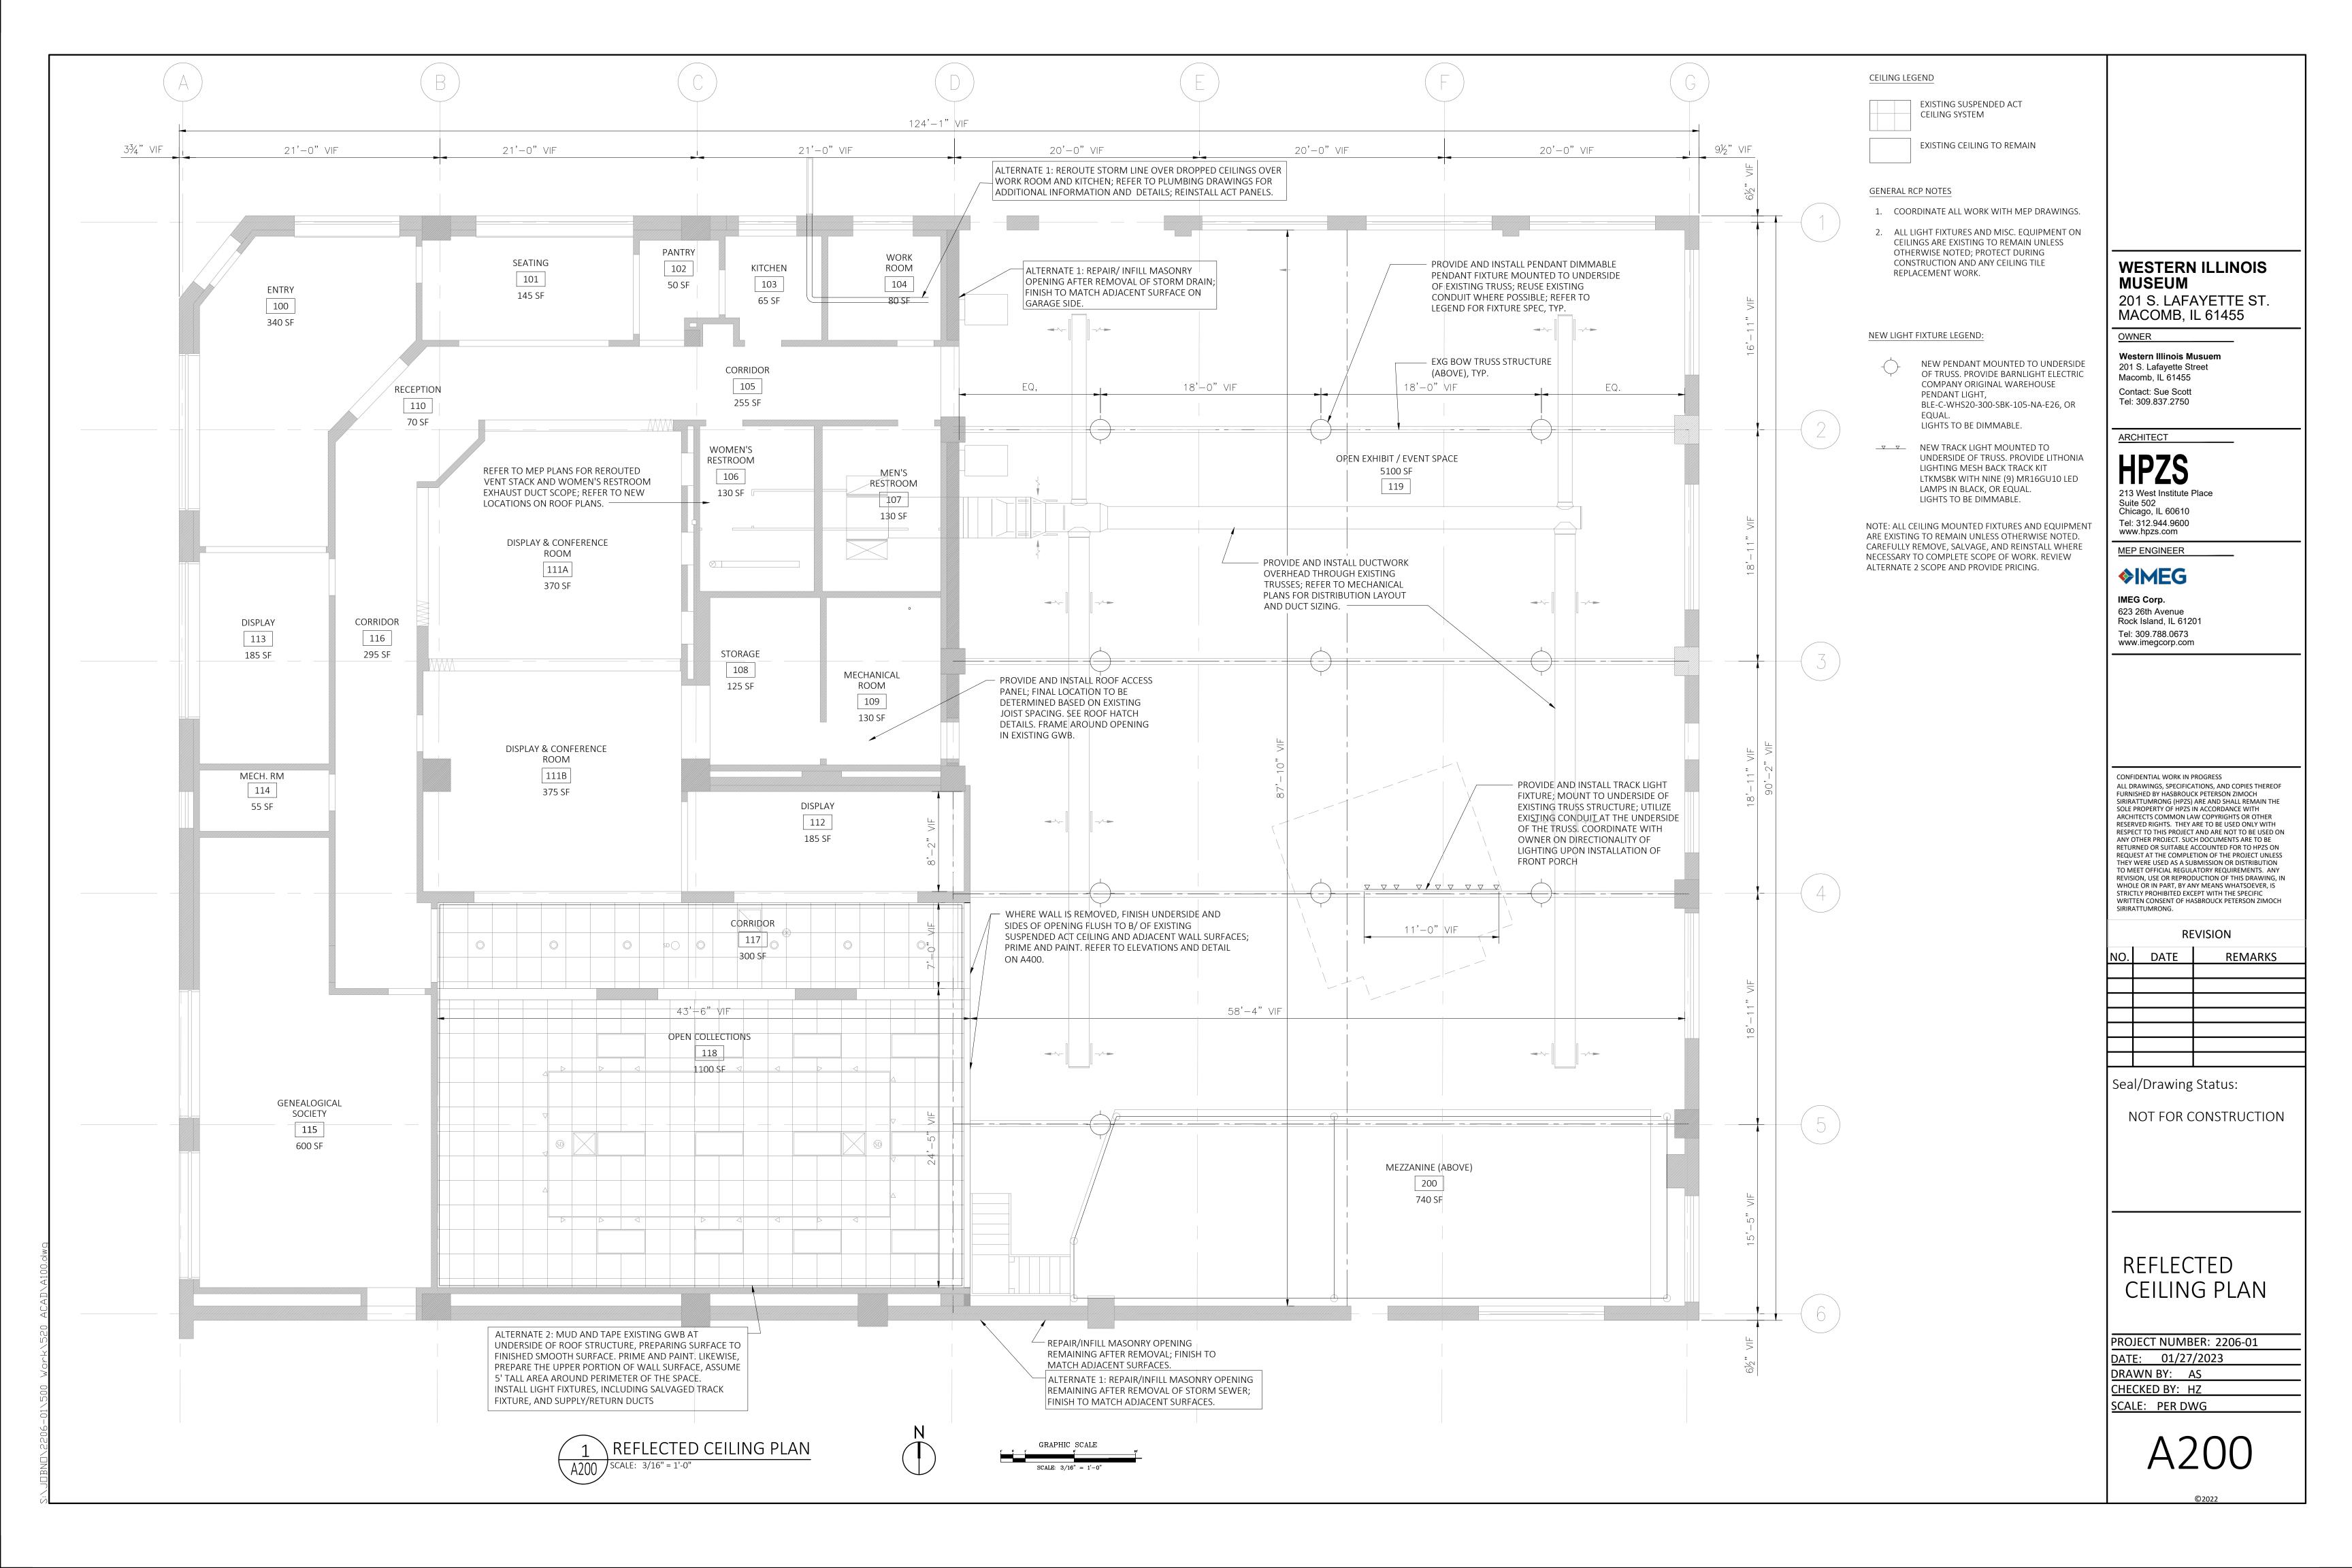

SECTION THRU NEW OPENING - BASE SCOPE

A400 SCALE: 1/4" = 1'-0"

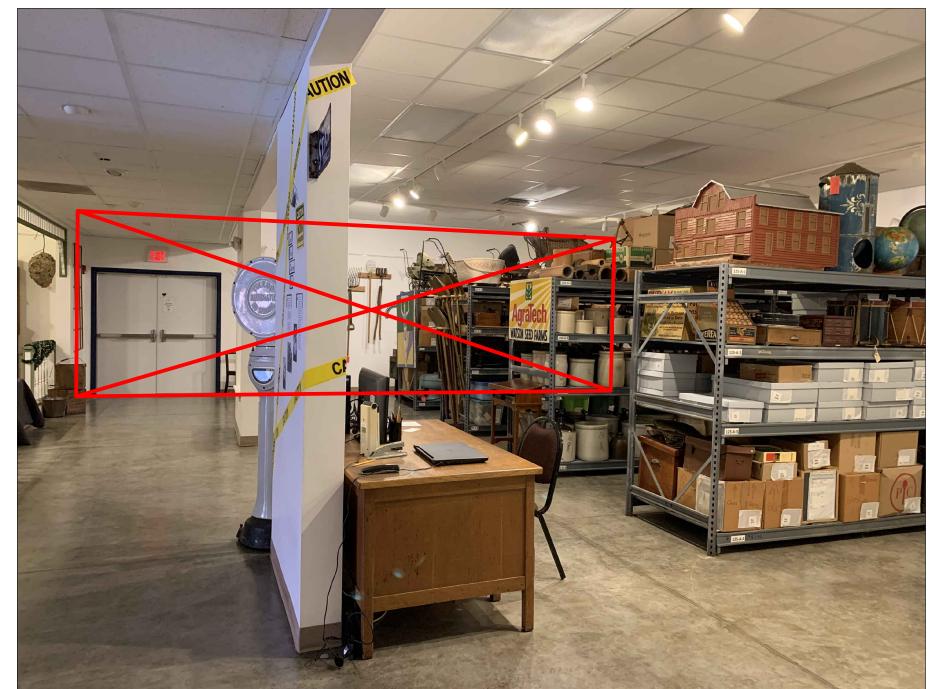




4 ELEVATION AT NEW OPENING - FROM WEST

A400 SCALE: 1/4" = 1'-0"



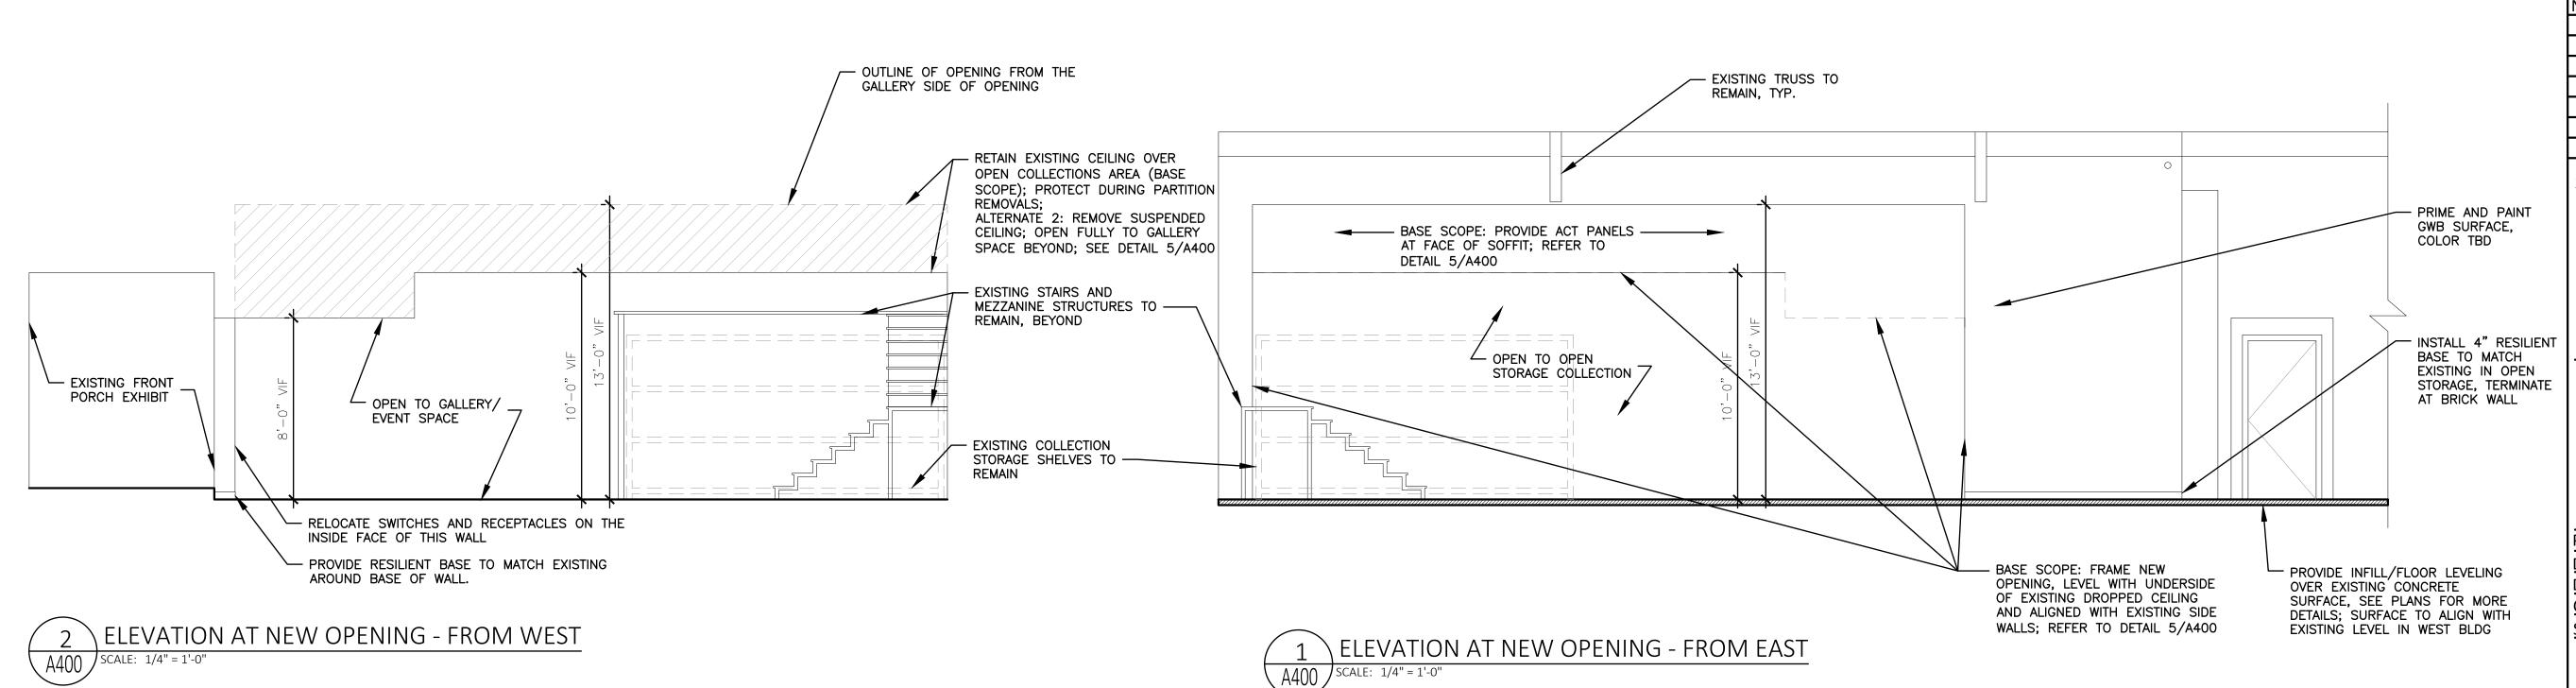

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OWNER

Western Illinois Musuem 201 S. Lafayette Street Macomb, IL 61455 Contact: Sue Scott Tel: 309.837.2750

ARCHITECT

BASE SCOPE: EXISTING STORM DRAIN TO REMAIN; ALTERNATE 1: REMOVE AND REROUTE EXISTING STORM; REFER TO PLANS

FOR SCOPE.

HPZS
213 West Institute Pla

213 West Institute Place Suite 502 Chicago, IL 60610 Tel: 312.944.9600 www.hpzs.com

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REVISION

DATE REMARKS

Seal/Drawing Status:

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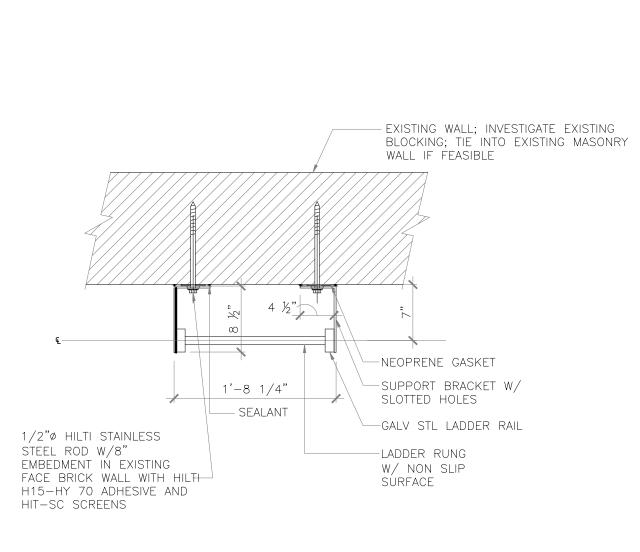
INTERIOR ELEVATIONS

PROJECT NUMBER: 2206-01


DATE: 01/27/2023
DRAWN BY: AS
CHECKED BY: HZ
SCALE: PER DWG

A400


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REVISION

NO.	DATE	REMARKS

Seal/Drawing Status:
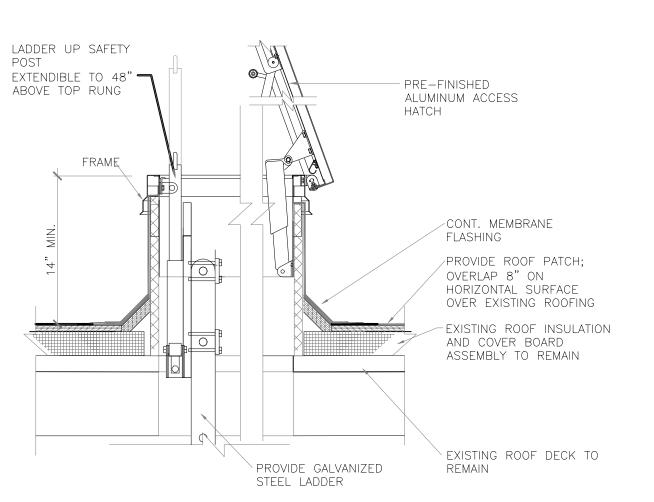
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DETAILS


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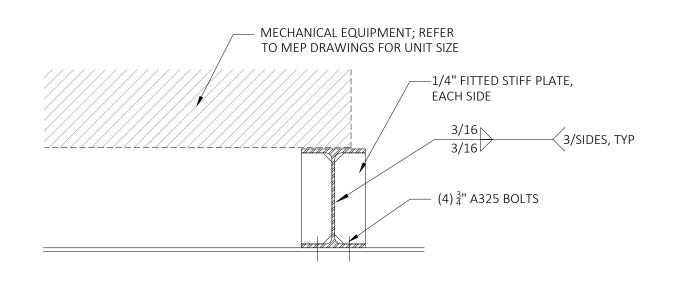
DATE: 01/27/2023
DRAWN BY: AS
CHECKED BY: HZ

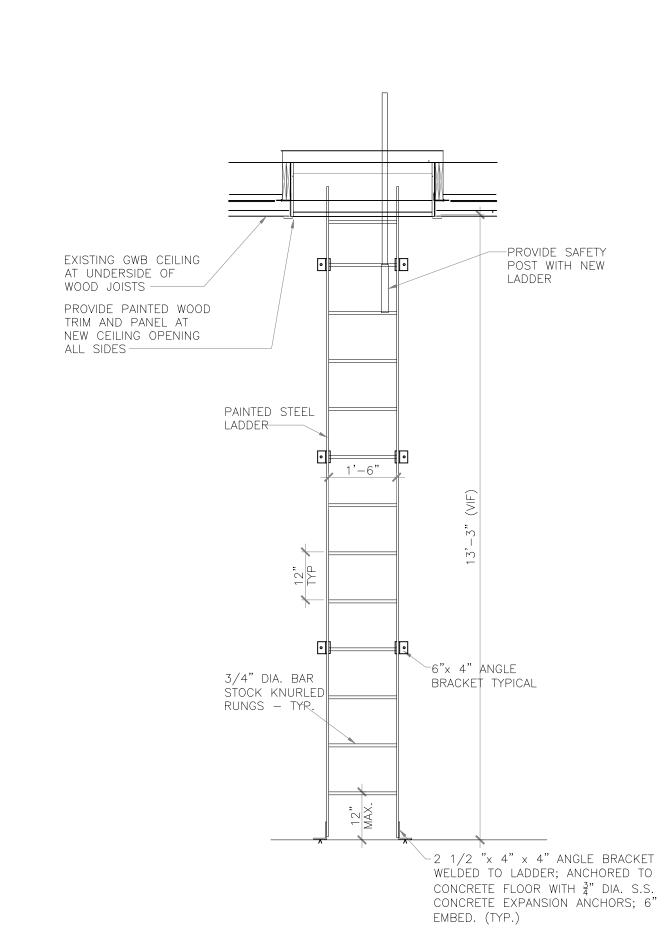SCALE: PER DWG

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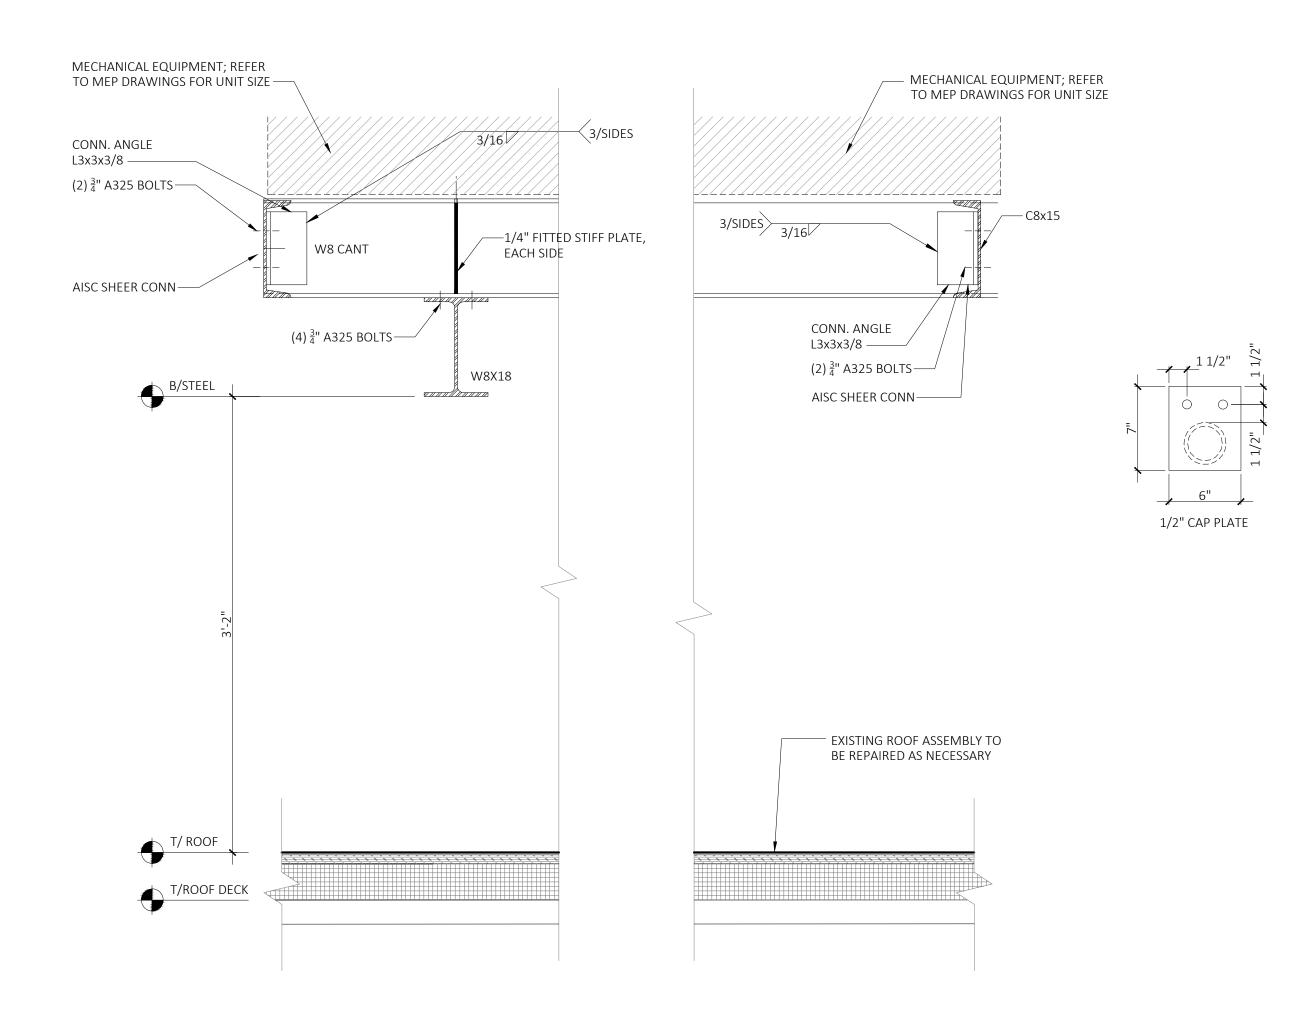
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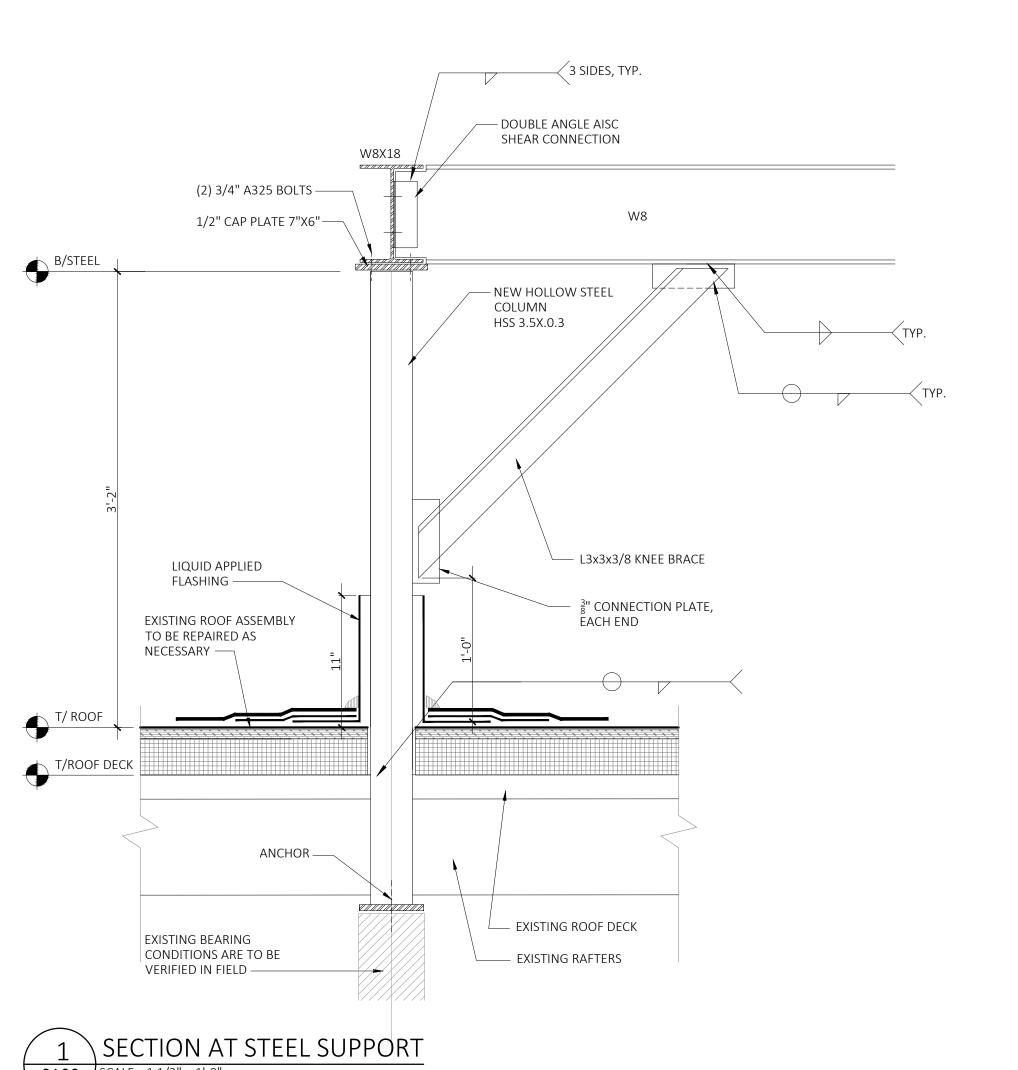




B/STEEL

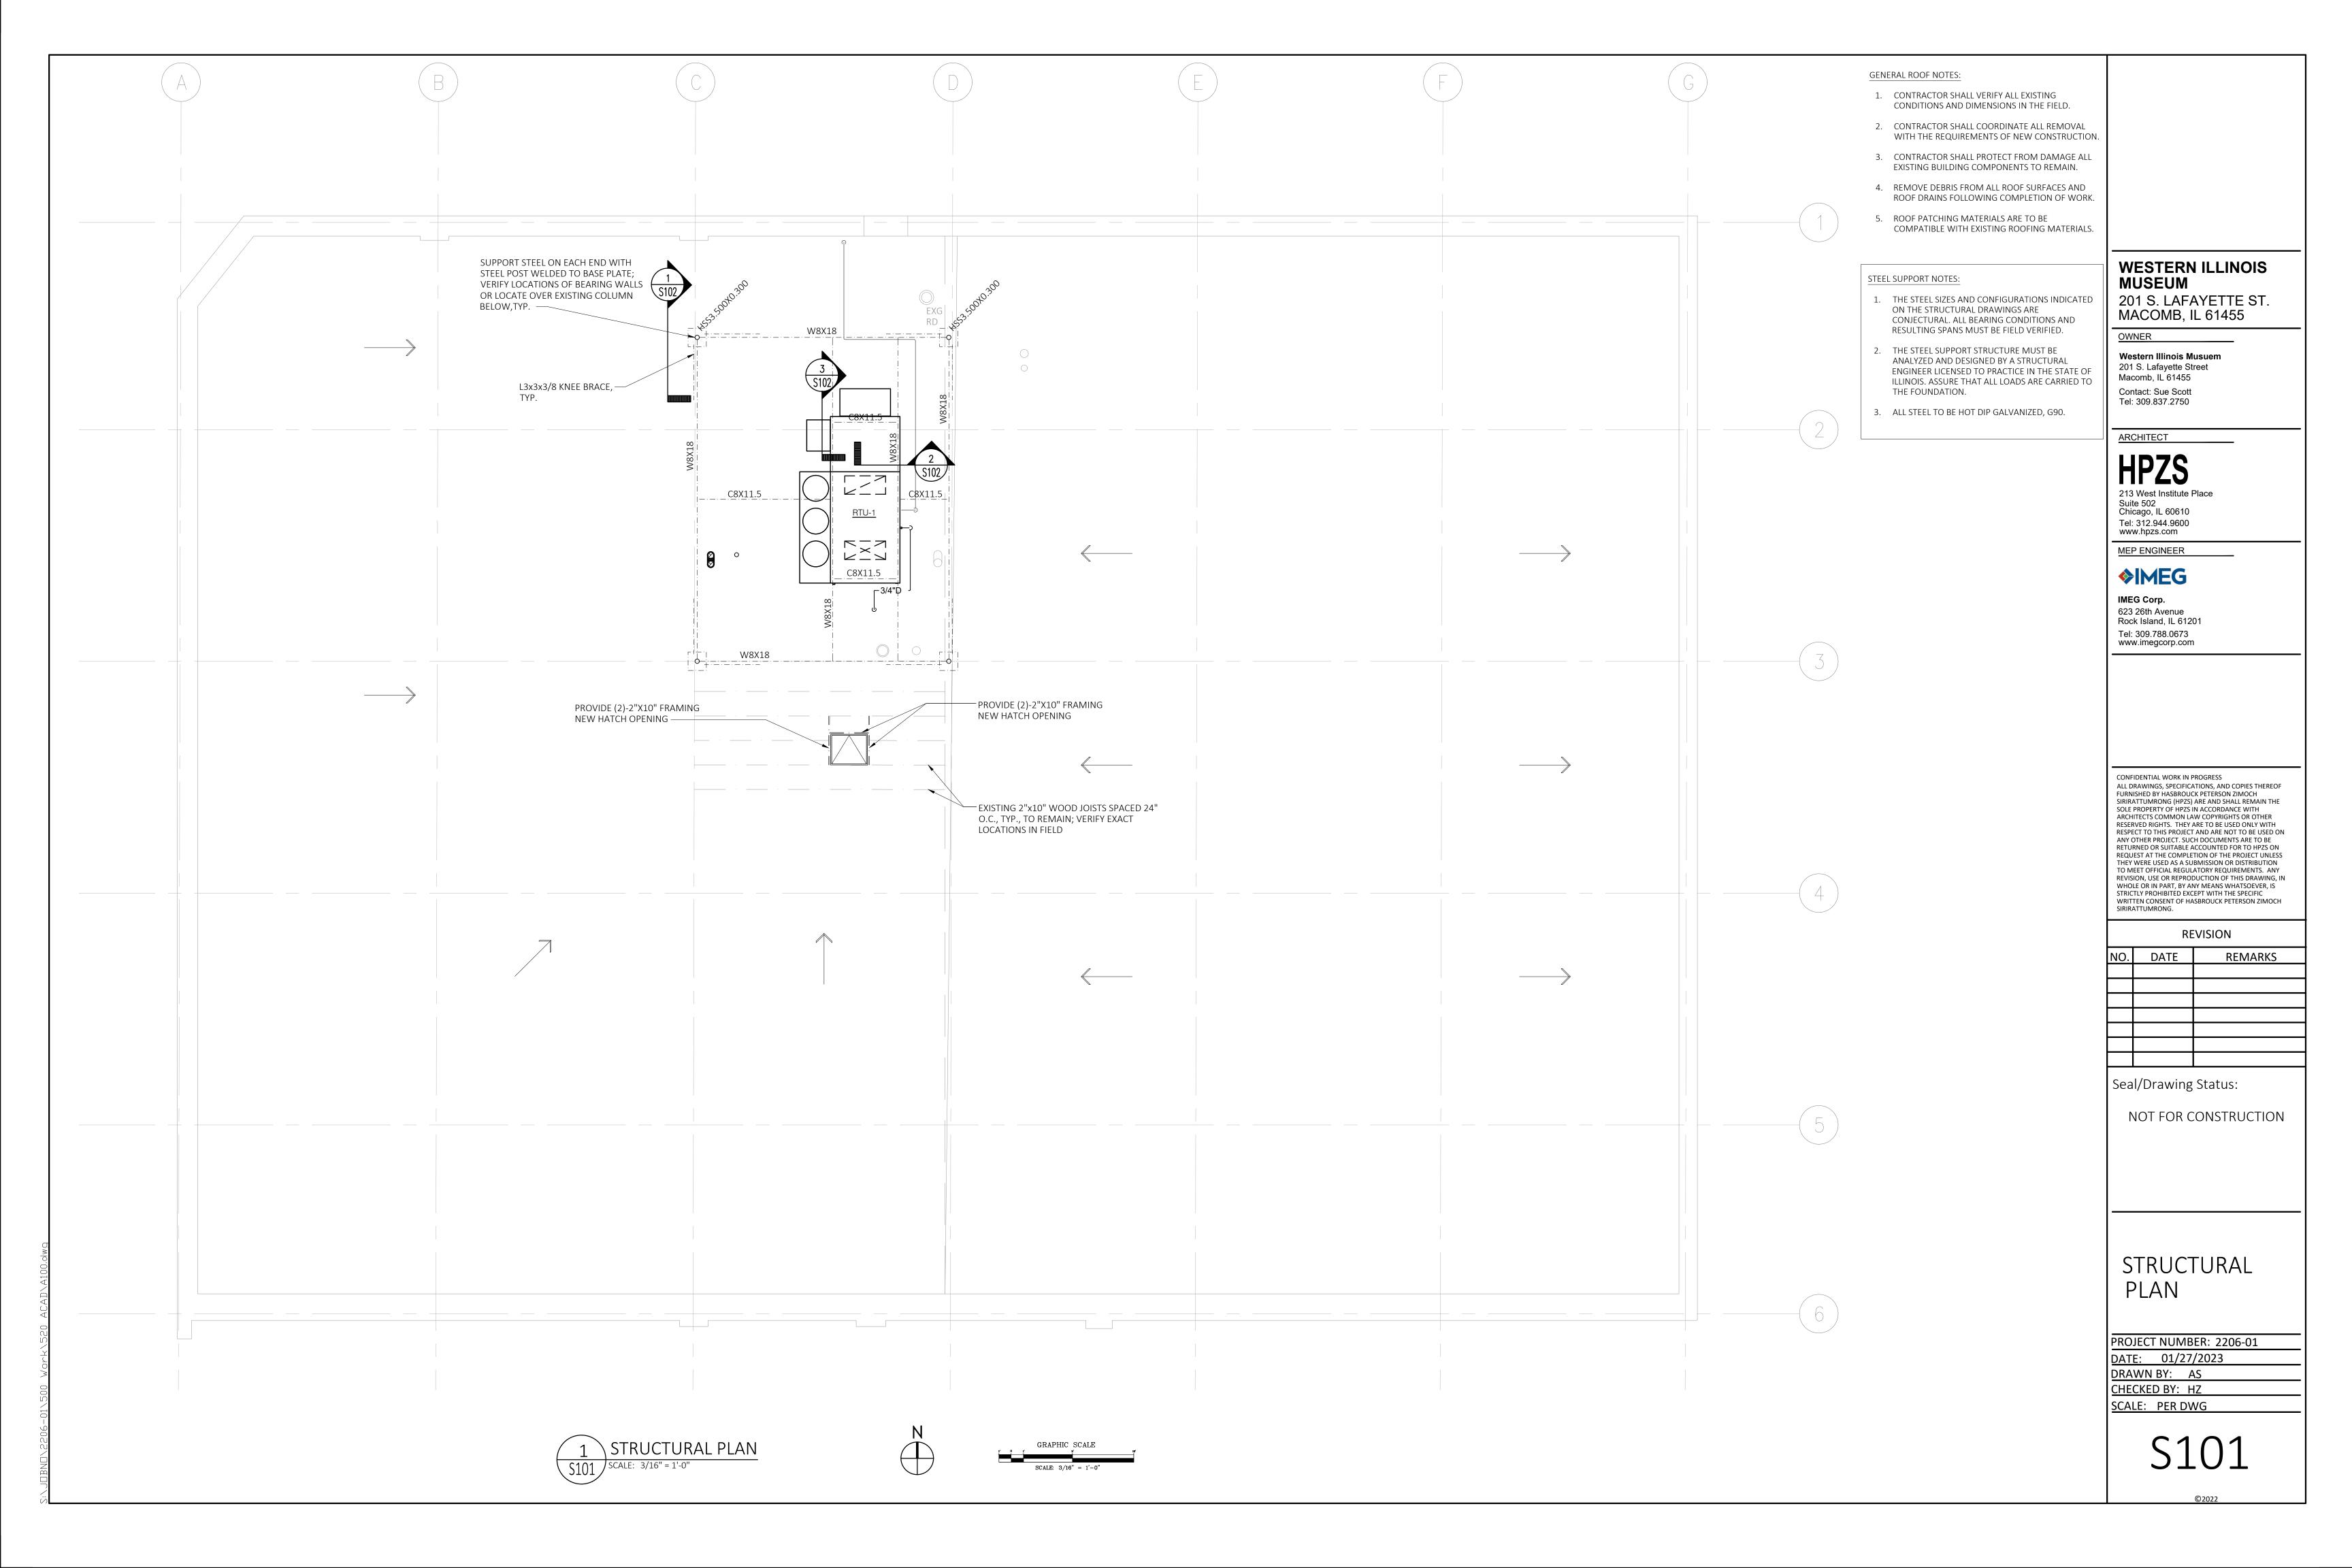





GENERAL ROOF NOTES:

- 1. CONTRACTOR SHALL VERIFY ALL EXISTING CONDITIONS AND DIMENSIONS IN THE FIELD.
- 2. CONTRACTOR SHALL COORDINATE ALL REMOVAL
- WITH THE REQUIREMENTS OF NEW CONSTRUCTION. 3. CONTRACTOR SHALL PROTECT FROM DAMAGE ALL
- EXISTING BUILDING COMPONENTS TO REMAIN.
- 4. REMOVE DEBRIS FROM ALL ROOF SURFACES AND ROOF DRAINS FOLLOWING COMPLETION OF WORK.
- 5. ROOF PATCHING MATERIALS ARE TO BE COMPATIBLE WITH EXISTING ROOFING MATERIALS.

#### STEEL SUPPORT NOTES:

- 1. THE STEEL SIZES AND CONFIGURATIONS INDICATED ON THE STRUCTURAL DRAWINGS ARE CONJECTURAL. ALL BEARING CONDITIONS AND RESULTING SPANS MUST BE FIELD VERIFIED.
- 2. THE STEEL SUPPORT STRUCTURE MUST BE ANALYZED AND DESIGNED BY A STRUCTURAL ENGINEER LICENSED TO PRACTICE IN THE STATE OF ILLINOIS. ASSURE THAT ALL LOADS ARE CARRIED TO THE FOUNDATION.
- 3. ALL STEEL TO BE HOT DIP GALVANIZED, G90.

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SIRIRATTUMRONG.

NO.	DATE	REMARKS

Seal/Drawing Status:

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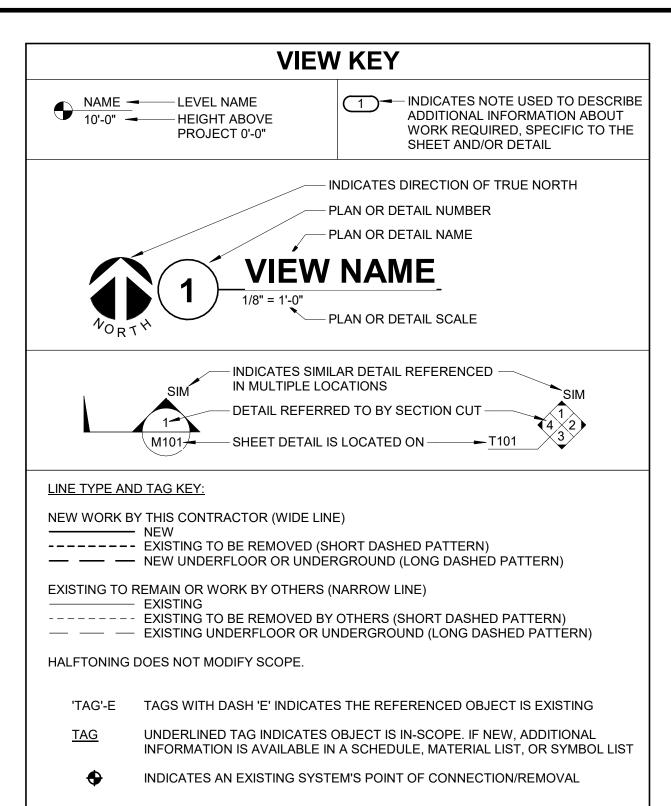
STRUCTURAL DETAILS

PROJECT NUMBER: 2206-01

DATE: 01/27/2023 DRAWN BY: AS CHECKED BY: HZ SCALE: PER DWG

GRAPHIC SCALE

SCALE: 1-1/2" = 1'-0"



APPLICABLE CODES		
CONTRACTOR SHALL COMPLY V	WITH APPLICABLE CODES AND LOCAL AMENDMENTS.	
BUILDING CODE:	IBC 2018 EDITION	
FIRE CODE:	IFC 2018 EDITION	
PLUMBING CODE:	ILLINOIS PLUMBING CODE	
MECHANICAL CODE:	IMC 2018 EDITION	
ELECTRICAL CODE:	NFPA 70 (NEC) 2020 EDITION	
LIFE SAFETY CODE:	NFPA 101 CURRENT EDITION	
ENERGY CONSERVATION CODE:	IECC 2018	
LOCAL BUILDING CODE:	CURRENT EDITION	

CONTRACTOR ABBREVIATION KEY		
ABBR:	DESCRIPTION:	
E.C.	ELECTRICAL CONTRACTOR	
M.C.	MECHANICAL CONTRACTOR	

CONTACT PERSONS:		
DESCRIPTION:	PERSON:	
PROJECT MANAGER	MATT SNYDER	
MECHANICAL	ERIC BUSCH	
ELECTRICAL	ADAM BROCKMAN	

	MECHANICAL SYMBOL LIST
	NOT ALL SYMBOLS MAY APPLY.
SYMBOL:	DESCRIPTION:
D	DRAIN - PLUMBING
——G——	NATURAL GAS
—ST(1,000)—	STORM DRAINAGE (ROOF SQUARE FOOTAGE)
<del></del>	PIPE CAP
	PIPE DOWN
	PIPE UP OR UP/DOWN
——————————————————————————————————————	PIPE SERVING FIXTURE ON FLOOR ABOVE (EXAMPLE: FD = FLOOR DRAIN)
	PITCH PIPE IN DIRECTION
	DIRECTION OF FLOW IN PIPE
7	ROUTE TO DRAIN
<u>RD-1</u> 6"(1000)	ROOF DRAIN PROPERTIES SYMBOL SIZE (ROOF SQ. FT.)
——II——	UNION/FLANGE
<b>──</b>	SHUTOFF VALVE NORMALLY OPEN
<b>———</b>	SHUTOFF VALVE NORMALLY CLOSED
<b>——</b> D——	REDUCER - REFERENCE SPECIFICATION FOR CONCENTRIC/ECCENTRIC AND FOT/FOB
<b>*</b>	DRAIN VALVE WITH HOSE CONNECTION AND CAP
<u>-</u> M	METER
	DUCT CAP
	DUCT DOWN
	DUCT UP
$\boxtimes$	SUPPLY/OUTSIDE AIR DUCT SECTION
	RETURN AIR DUCT SECTION
<u>SD-1</u> 6/115	AIR TERMINAL PROPERTIES SYMBOL NECK SIZE/CFM
XX-Y	AIRFLOW MEASUREMENT SYMBOL XX - AHU SYMBOL Y - SEQUENTIAL NUMBER
•—	NORMALL CLOSED CONTACT
<b></b>	NORMALLY OPEN CONTACT
⊏≈	MONITOR SWITCH
•—•	DIFFERENTIAL PRESSURE SENSOR

	MECHANICAL ABBREVIATION KEY
ABBR:	DESCRIPTION:
AD	ACCESS DOOR
AFF	ABOVE FINISHED FLOOR
CO	CLEANOUT
DPG (0-2")	DIFFERENTIAL PRESSURE GAUGE (RANGE)
DPS	DIFFERENTIAL PRESSURE SWITCH
Е	EXISTING
FCO	FLOOR CLEANOUT
RA	RETURN AIR
SA	SUPPLY AIR

TYP

TYPICAL

#### **MECHANICAL GENERAL NOTES:**

THESE NOTES APPLY TO ALL MECHANICAL SHEETS AND TRADES, INCLUDING BUT NOT LIMITED TO, FIRE PROTECTION, PLUMBING, VENTILATION, PIPING AND TEMPERATURE CONTROL.

- 1. DRAWINGS SHOWING LOCATIONS OF EQUIPMENT, DUCTWORK, PIPING, ETC. ARE DIAGRAMMATIC AND MAY NOT ALWAYS REFLECT EXACT INSTALLATION CONDITIONS. DRAWINGS SHOW THE GENERAL ARRANGEMENT OF DUCTWORK, PIPING, EQUIPMENT, ETC., AND MAY NOT INCLUDE ALL OFFSETS AND FITTINGS REQUIRED FOR COMPLETE INSTALLATION. THE DRAWINGS SHALL BE FOLLOWED AS CLOSELY AS ACTUAL BUILDING CONSTRUCTION AND THE WORK OF OTHERS WILL PERMIT.
- 2. DO NOT SCALE DRAWINGS. VERIFY ALL DIMENSIONS AND CLEARANCES FROM ARCHITECTURAL, STRUCTURAL, SUBMITTALS, AND OTHER APPROPRIATE DRAWINGS OR PHYSICALLY AT SITE. REVIEW ALL DRAWINGS, INCLUDING THOSE OF OTHER TRADES.
- 3. COORDINATE ALL WORK WITH ALL OTHER TRADES PRIOR TO INSTALLATION TO PROVIDE CLEARANCES REQUIRED FOR OPERATION, MAINTENANCE, CODE COMPLIANCE, AND TO VERIFY NON-INTERFERENCE WITH OTHER WORK. DO NOT FABRICATE PRIOR TO VERIFICATION OF NECESSARY CLEARANCES FOR ALL TRADES. BRING ANY INTERFERENCES OR CONFLICTS TO THE ATTENTION OF THE ARCHITECT/ENGINEER BEFORE PROCEEDING WITH FABRICATION OR EQUIPMENT ORDERS.
- 4. REVIEW SPACE REQUIREMENTS OF EQUIPMENT SPECIFIED OR SUBSTITUTED AND MAKE REASONABLE ACCOMMODATIONS IN LAYOUT AND POSITIONING TO PROVIDE PROPER
- 5. ANY CHANGES REQUIRED TO ELIMINATE CONFLICTS OR THAT RESULT FROM A FAILURE TO COORDINATE SHALL BE MADE BY THE CONTRACTOR WITHOUT ADDITIONAL COST OR
- EXPENSE TO OTHERS.

  6. EACH CONTRACTOR IS RESPONSIBLE FOR ALL COSTS ASSOCIATED WITH ELECTRICAL CHANGES REQUIRED FOR EQUIPMENT PROPOSED THAT DIFFERS FROM THE BASIS OF
- 7. EACH CONTRACTOR IS RESPONSIBLE FOR DAMAGE CAUSED BY THEIR ACTIONS TO WALLS, FLOORS, CEILINGS, AND ROOFS. THE CONTRACTOR WHOSE WORK CAUSES DAMAGE IS RESPONSIBLE FOR PATCHING TO MATCH ORIGINAL CONSTRUCTION, FIRE RATING, AND
- 8. SEAL ALL FLOOR, WALL, AND ROOF PENETRATIONS AIRTIGHT WHERE CONDUITS, PIPING, AND DUCTS PENETRATE. PENETRATIONS THROUGH EXTERIOR WALLS AND ROOF SHALL BE SEALED AIRTIGHT WITH WATERPROOFING MATERIALS RECOMMENDED BY MANUFACTURER FOR OUTDOOR USE.
- 9. CAULK ALL PIPE AND DUCT PENETRATIONS OF FULL HEIGHT NON-FIRE RATED WALL, PARTITION, FLOOR, AND ROOF ASSEMBLIES. THIS IS ESSENTIAL TO PREVENT NOISE TRANSMISSION FROM ONE ROOM TO ANOTHER AND TO PROVIDE THE DESIRED NC LEVELS
- WITHIN ROOMS.

  10. WHERE PIPES AND DUCTS ARE SHOWN TO PENETRATE FLOORS, PROVIDE SLEEVED OPENINGS WITH THE TOP EDGE RAISED ABOVE FLOOR SURFACE IN ACCORDANCE WITH ALL
- RELEVANT SPEC SECTIONS. SEAL SLEEVE PERIMETER TO BE WATERTIGHT.

  11. EQUIPMENT SIZES AND SERVICE CLEARANCE REQUIREMENTS VARY AMONG DIFFERENT MANUFACTURERS. CONSULT APPROVED SHOP DRAWINGS FOR EQUIPMENT SIZES AND REQUIRED SERVICE CLEARANCES. COORDINATE WITH LAYOUT OF EQUIPMENT PADS.
- MANUFACTURERS. CONSULT APPROVED SHOP DRAWINGS FOR EQUIPMENT SIZES AND REQUIRED SERVICE CLEARANCES. COORDINATE WITH LAYOUT OF EQUIPMENT PADS, PIPING, DUCTWORK, ETC.

  12. DO NOT BLOCK TUBE PULL OR EQUIPMENT SERVICE CLEARANCES.
- 13. MAINTAIN A MINIMUM WORKING CLEARANCE OF 3'-6" IN FRONT OF ALL ELECTRICAL EQUIPMENT REQUIRING MAINTENANCE, INSPECTION, AND TESTING INCLUDING BUT NOT LIMITED TO PANELS, DISTRIBUTION PANELS, SWITCHBOARDS, MOTOR CONTROL CENTERS, TRANSFORMERS, EQUIPMENT DISCONNECTS AND STARTERS.
- 14. MAINTAIN THE DEDICATED ELECTRICAL EQUIPMENT SPACE DEFINED BY THE WIDTH / DEPTH OF ELECTRICAL EQUIPMENT MEASURED FROM THE FLOOR TO A HEIGHT 6'-0" ABOVE THE EQUIPMENT OR THE STRUCTURAL CEILING, WHICHEVER IS LOWER. SYSTEMS FOREIGN TO THE ELECTRICAL DISTRIBUTION SYSTEM ARE NOT ALLOWED IN THE DEDICATED ELECTRICAL SPACE INCLUDING; DUCTWORK, PIPING, ETC.
- 15. DO NOT SUPPORT EQUIPMENT, PIPING, OR DUCTWORK FROM METAL DECKING OR OTHER NON-STRUCTURAL BUILDING ELEMENTS. ANCHORS EMBEDDED IN CONCRETE SHALL BE CRACKED CONCRETE APPROVED IN ACCORDANCE WITH SPECIFICATIONS.

#### **PLUMBING GENERAL NOTES:**

- 1. THE SYMBOLS AND THE MATERIAL LIST ARE FOR THE CONVENIENCE OF THE CONTRACTOR. CONTRACTOR SHALL VERIFY QUANTITIES AND FURNISH ALL MATERIALS REQUIRED FOR FULLY OPERATIONAL SYSTEMS, WHETHER SPECIFIED OR NOT.
- 2. CATALOG NUMBERS SHALL NOT BE CONSIDERED COMPLETE, BUT ARE GIVEN AS AN AID TO THE CONTRACTOR AND TO INDICATE THE QUALITY REQUIRED. CONTRACTOR IS RESPONSIBLE FOR A COMPLETE DESCRIPTION OF MATERIAL ON THESE DRAWINGS AND IN THE SPECIFICATIONS BEFORE ORDERING. THE DESCRIPTION OF THE MATERIAL TAKES PRECEDENCE OVER THE CATALOG NUMBER. THE FIRST MANUFACTURER LISTED IS THE BASIS OF DESIGN.
- CONTRACTOR SHALL VERIFY THAT FIXTURES SUPPLIED ARE APPROVED PER ALL APPLICABLE STATE, LOCAL AND GOVERNING AUTHORITIES.
- 4. ALL FIXTURES SHALL CONFORM TO FEDERAL ACT S.3874
- EXISTING CONDITIONS ON DEMOLITION PLANS ARE PROVIDED TO INDICATE THE GENERAL SCOPE OF ITEMS TO BE REMOVED. REFER TO SPECIFICATION SECTION 22 05 05 FOR ADDITIONAL DEMOLITION INFORMATION.
- 6. P.C. SHALL CUT AND PATCH EXISTING AS REQUIRED FOR NEW OR DEMOLITION WORK UNLESS NOTED OTHERWISE. REFER TO SPECIFICATION SECTION 22 05 05 FOR ADDITIONAL INFORMATION.

#### **MECHANICAL RENOVATION NOTES:**

THESE NOTES APPLY TO ALL MECHANICAL SHEETS AND TRADES, INCLUDING BUT NOT LIMITED TO, FIRE PROTECTION, PLUMBING, VENTILATION, PIPING AND TEMPERATURE CONTROL.

- 1. EXISTING CONDITIONS ARE SHOWN BASED ON INFORMATION OBTAINED FROM FIELD SURVEYS, EXISTING BUILDING DOCUMENTS, AND STAFF. VERIFY EXISTING CONDITIONS AND REPORT ANY CONFLICTS BEFORE PROCEEDING.
- 2. NOT ALL EXISTING DUCTWORK AND PIPING IS SHOWN. VERIFY EXISTING CONDITIONS
- BEFORE STARTING WORK. NOTIFY ENGINEER OF ANY CONFLICTS WITH NEW WORK.

  3. FIELD VERIFY THE AVAILABLE CLEARANCES FOR DUCTWORK AND PIPING BEFORE FABRICATION. RISES AND DROPS MAY BE NECESSARY BECAUSE OF EXISTING FIELD
- CONDITIONS.

  4. EACH CONTRACTOR SHALL FIELD VERIFY ACCESSIBILITY TO THE AREA OF THEIR WORK AND SHALL NOTIFY THE GENERAL CONTRACTOR PRIOR TO BIDDING IF OTHER UTILITIES ARE
- REQUIRED TO BE REMOVED OR RELOCATED TO ALLOW ACCESS TO THEIR AREA OF WORK.

  5. WHERE EXISTING MECHANICAL SYSTEMS ARE LOCATED IN AREAS THAT CONFLICT WITH NEW EQUIPMENT, PIPING, OR DUCTWORK TO BE INSTALLED, EACH CONTRACTOR SHALL EITHER ARRANGE NEW EQUIPMENT, PIPING, OR DUCTWORK IN SUCH A FASHION THAT IT DOES NOT CONFLICT WITH EXISTING SYSTEMS, OR REWORK EXISTING MECHANICAL
- SYSTEMS TO ALLOW FOR INSTALLATION OF NEW EQUIPMENT, PIPING, OR DUCTWORK.

  6. DISCONNECT AND REMOVE MECHANICAL DEVICES AND EQUIPMENT SERVING EQUIPMENT THAT HAS BEEN REMOVED.

#### **VENTILATION GENERAL NOTES:**

- ALIGN TEMPERATURE SENSORS WITH LIGHT SWITCHES AND WHEN IN CLOSE PROXIMITY TO EACH OTHER.
- 2. PROVIDE ACCESS DOORS AT ALL DUCT MOUNTED EQUIPMENT.

MECHANICAL SHEET INDEX		
M002	MECHANICAL COVERSHEET	
M101	FLOOR PLAN DEMOLITION - MECHANICAL	
M211	FLOOR PLAN - VENTILATION	
M221	ROOF PLAN - VENTILATION	
M400	MECHANICAL DETAILS	
M600	MECHANICAL SCHEDULES	
P211	FLOOR PLAN - PLUMBING	
P221	ROOF PLAN - PLUMBING	
<b>GRAND TOTA</b>	L: 8	

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RE	EVISION
DATE	REMARKS

Seal/Drawing Status:

Not For Construction

Sheet Name MECHANICAL COVERSHEET

PROJECT NUMBER: 2206-01

DATE: 01/27/2023

DRAWN BY: Author

CHECKED BY: Checker

SCALE: As indicated

M002


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Illinois Design Firm Registration #184.007637-0014

PROJECT #22001384.00



NOTE: MECHANICAL CONTRACTOR SHALL PROVIDE FINAL DESIGN BUILD DRAWINGS FOR MECHANICAL SYSTEM AND ROUTING TO AOR FOR REVIEW

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10.	DATE	REMARKS

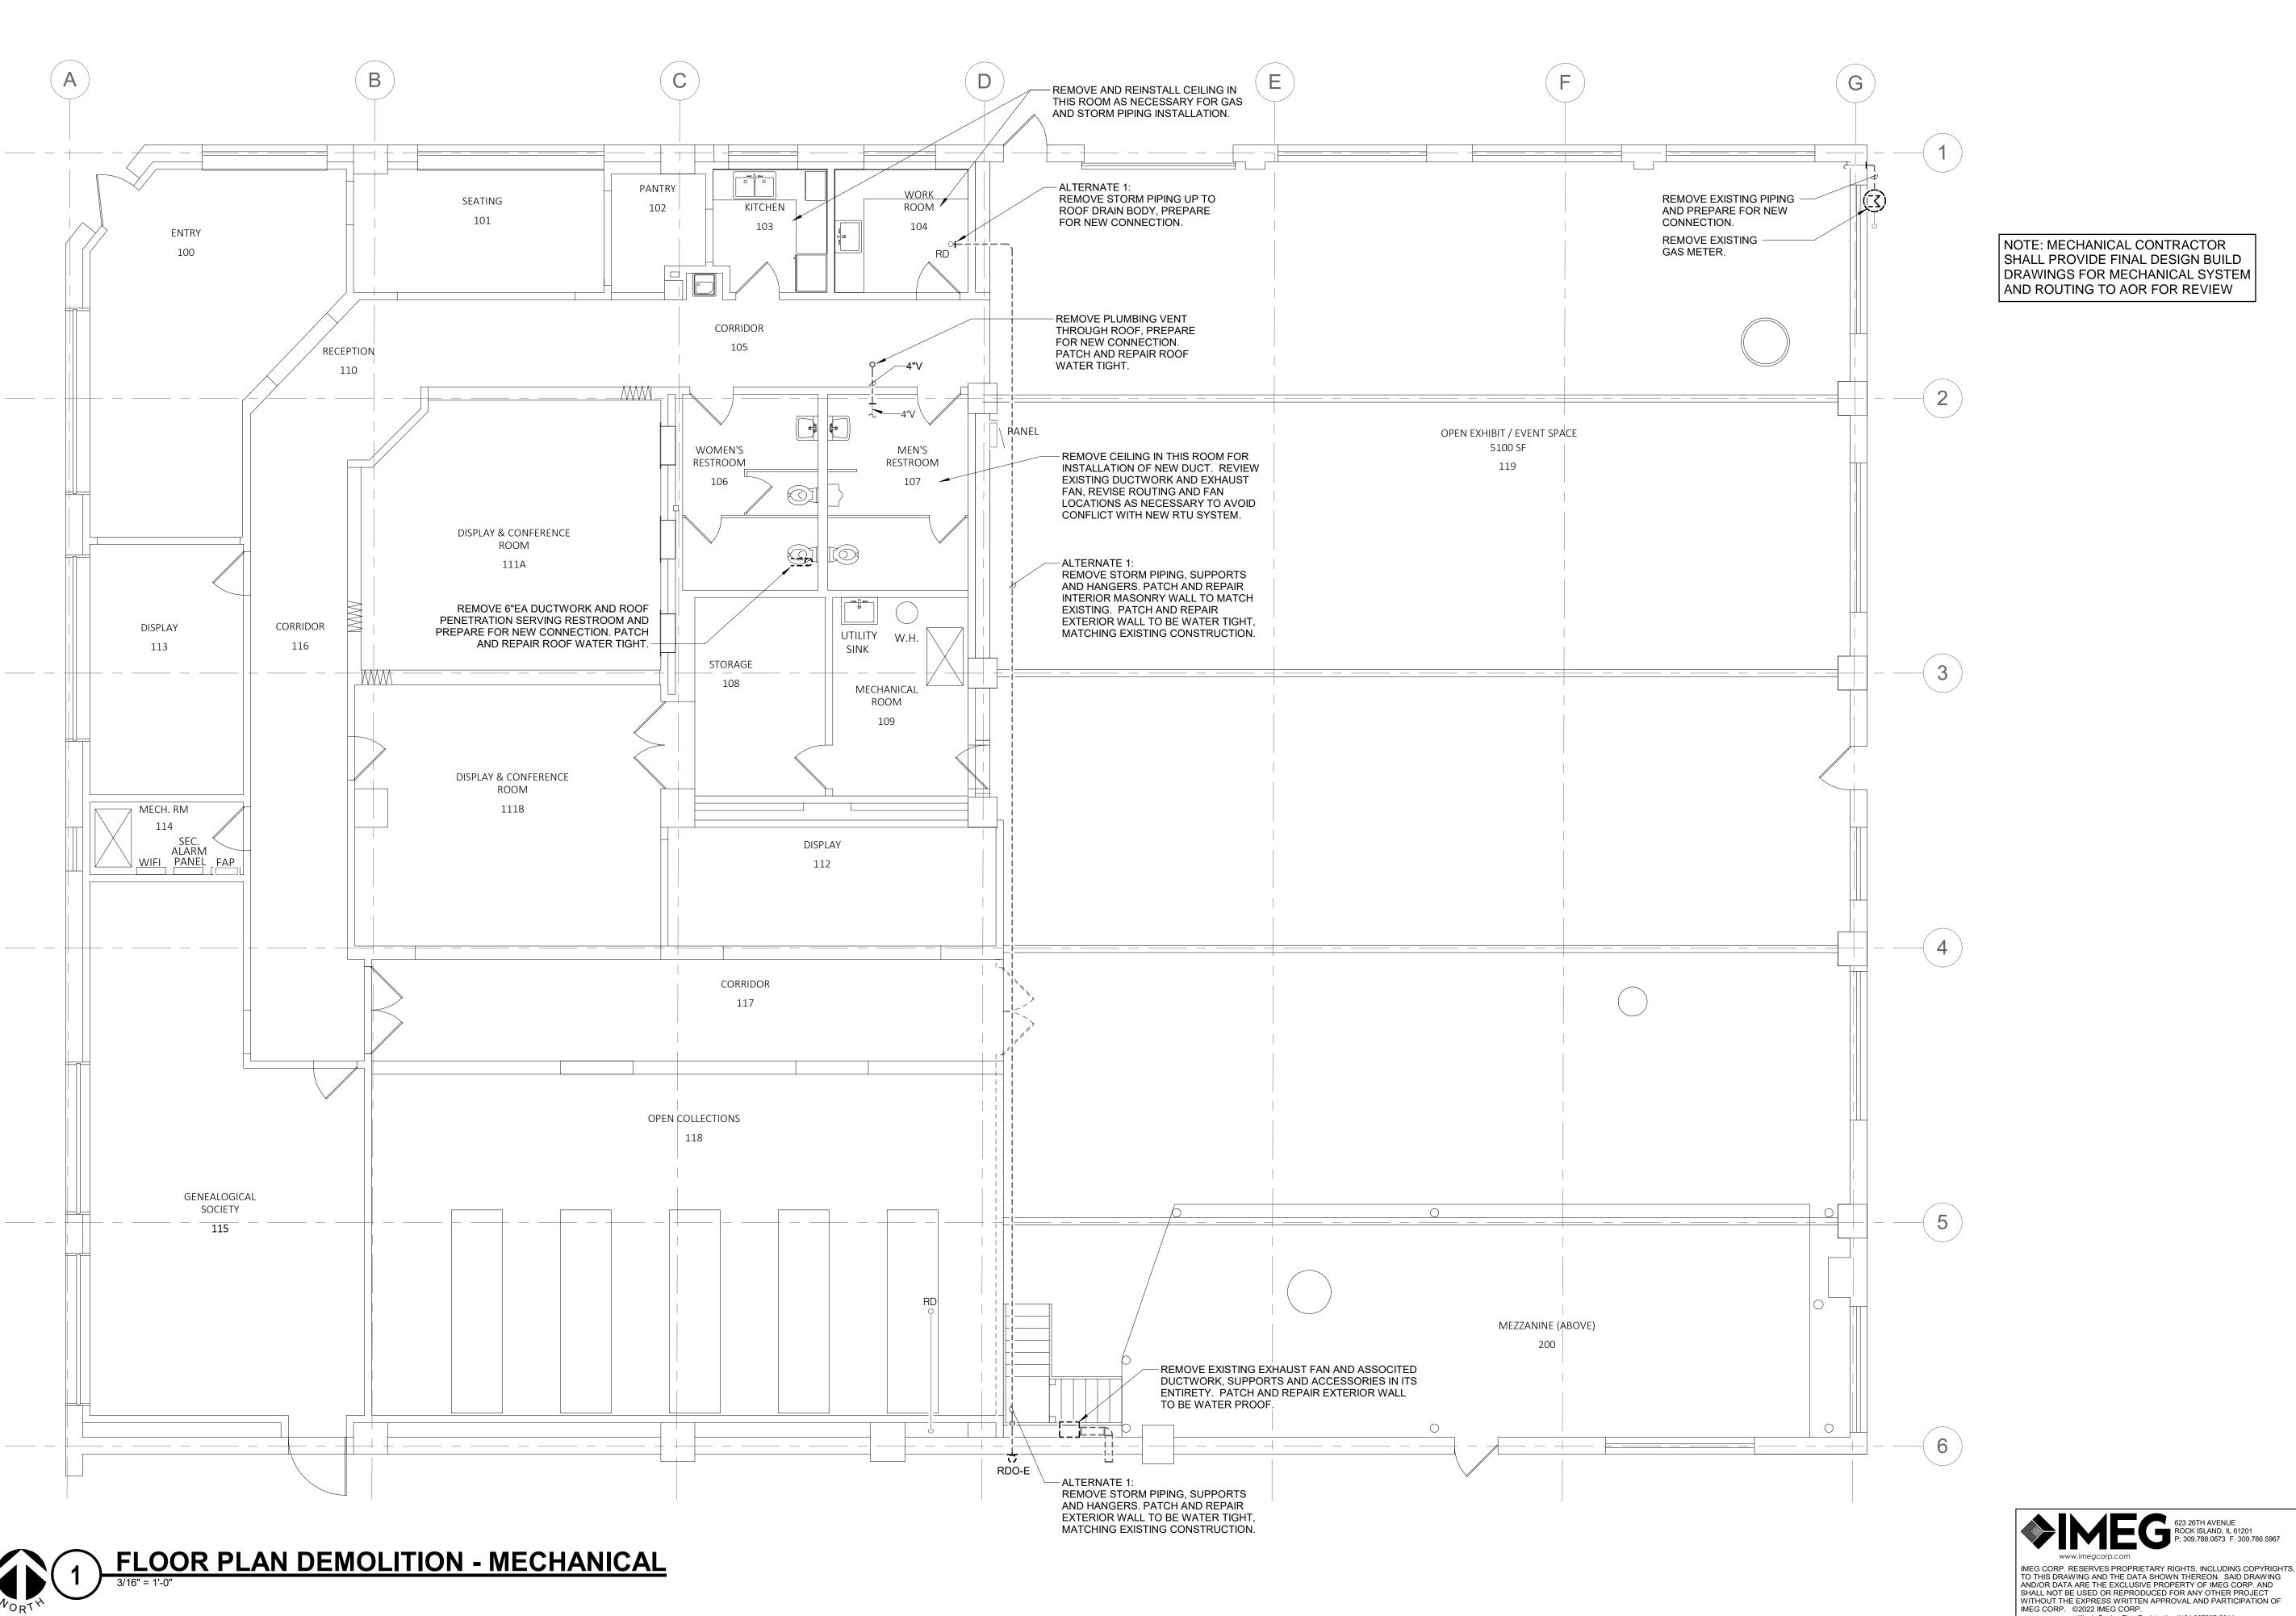Seal/Drawing Status:

Not For Construction

Sheet Name FLOOR PLAN **DEMOLITION -**

MECHANICAL PROJECT NUMBER: 2206-01


DATE: 01/27/2023 DRAWN BY: Author CHECKED BY: Checker SCALE: 3/16" = 1'-0"


Illinois Design Firm Registration #184.007637-0014


PROJECT #22001384.00

REF. SCALE IN INCHES

M101

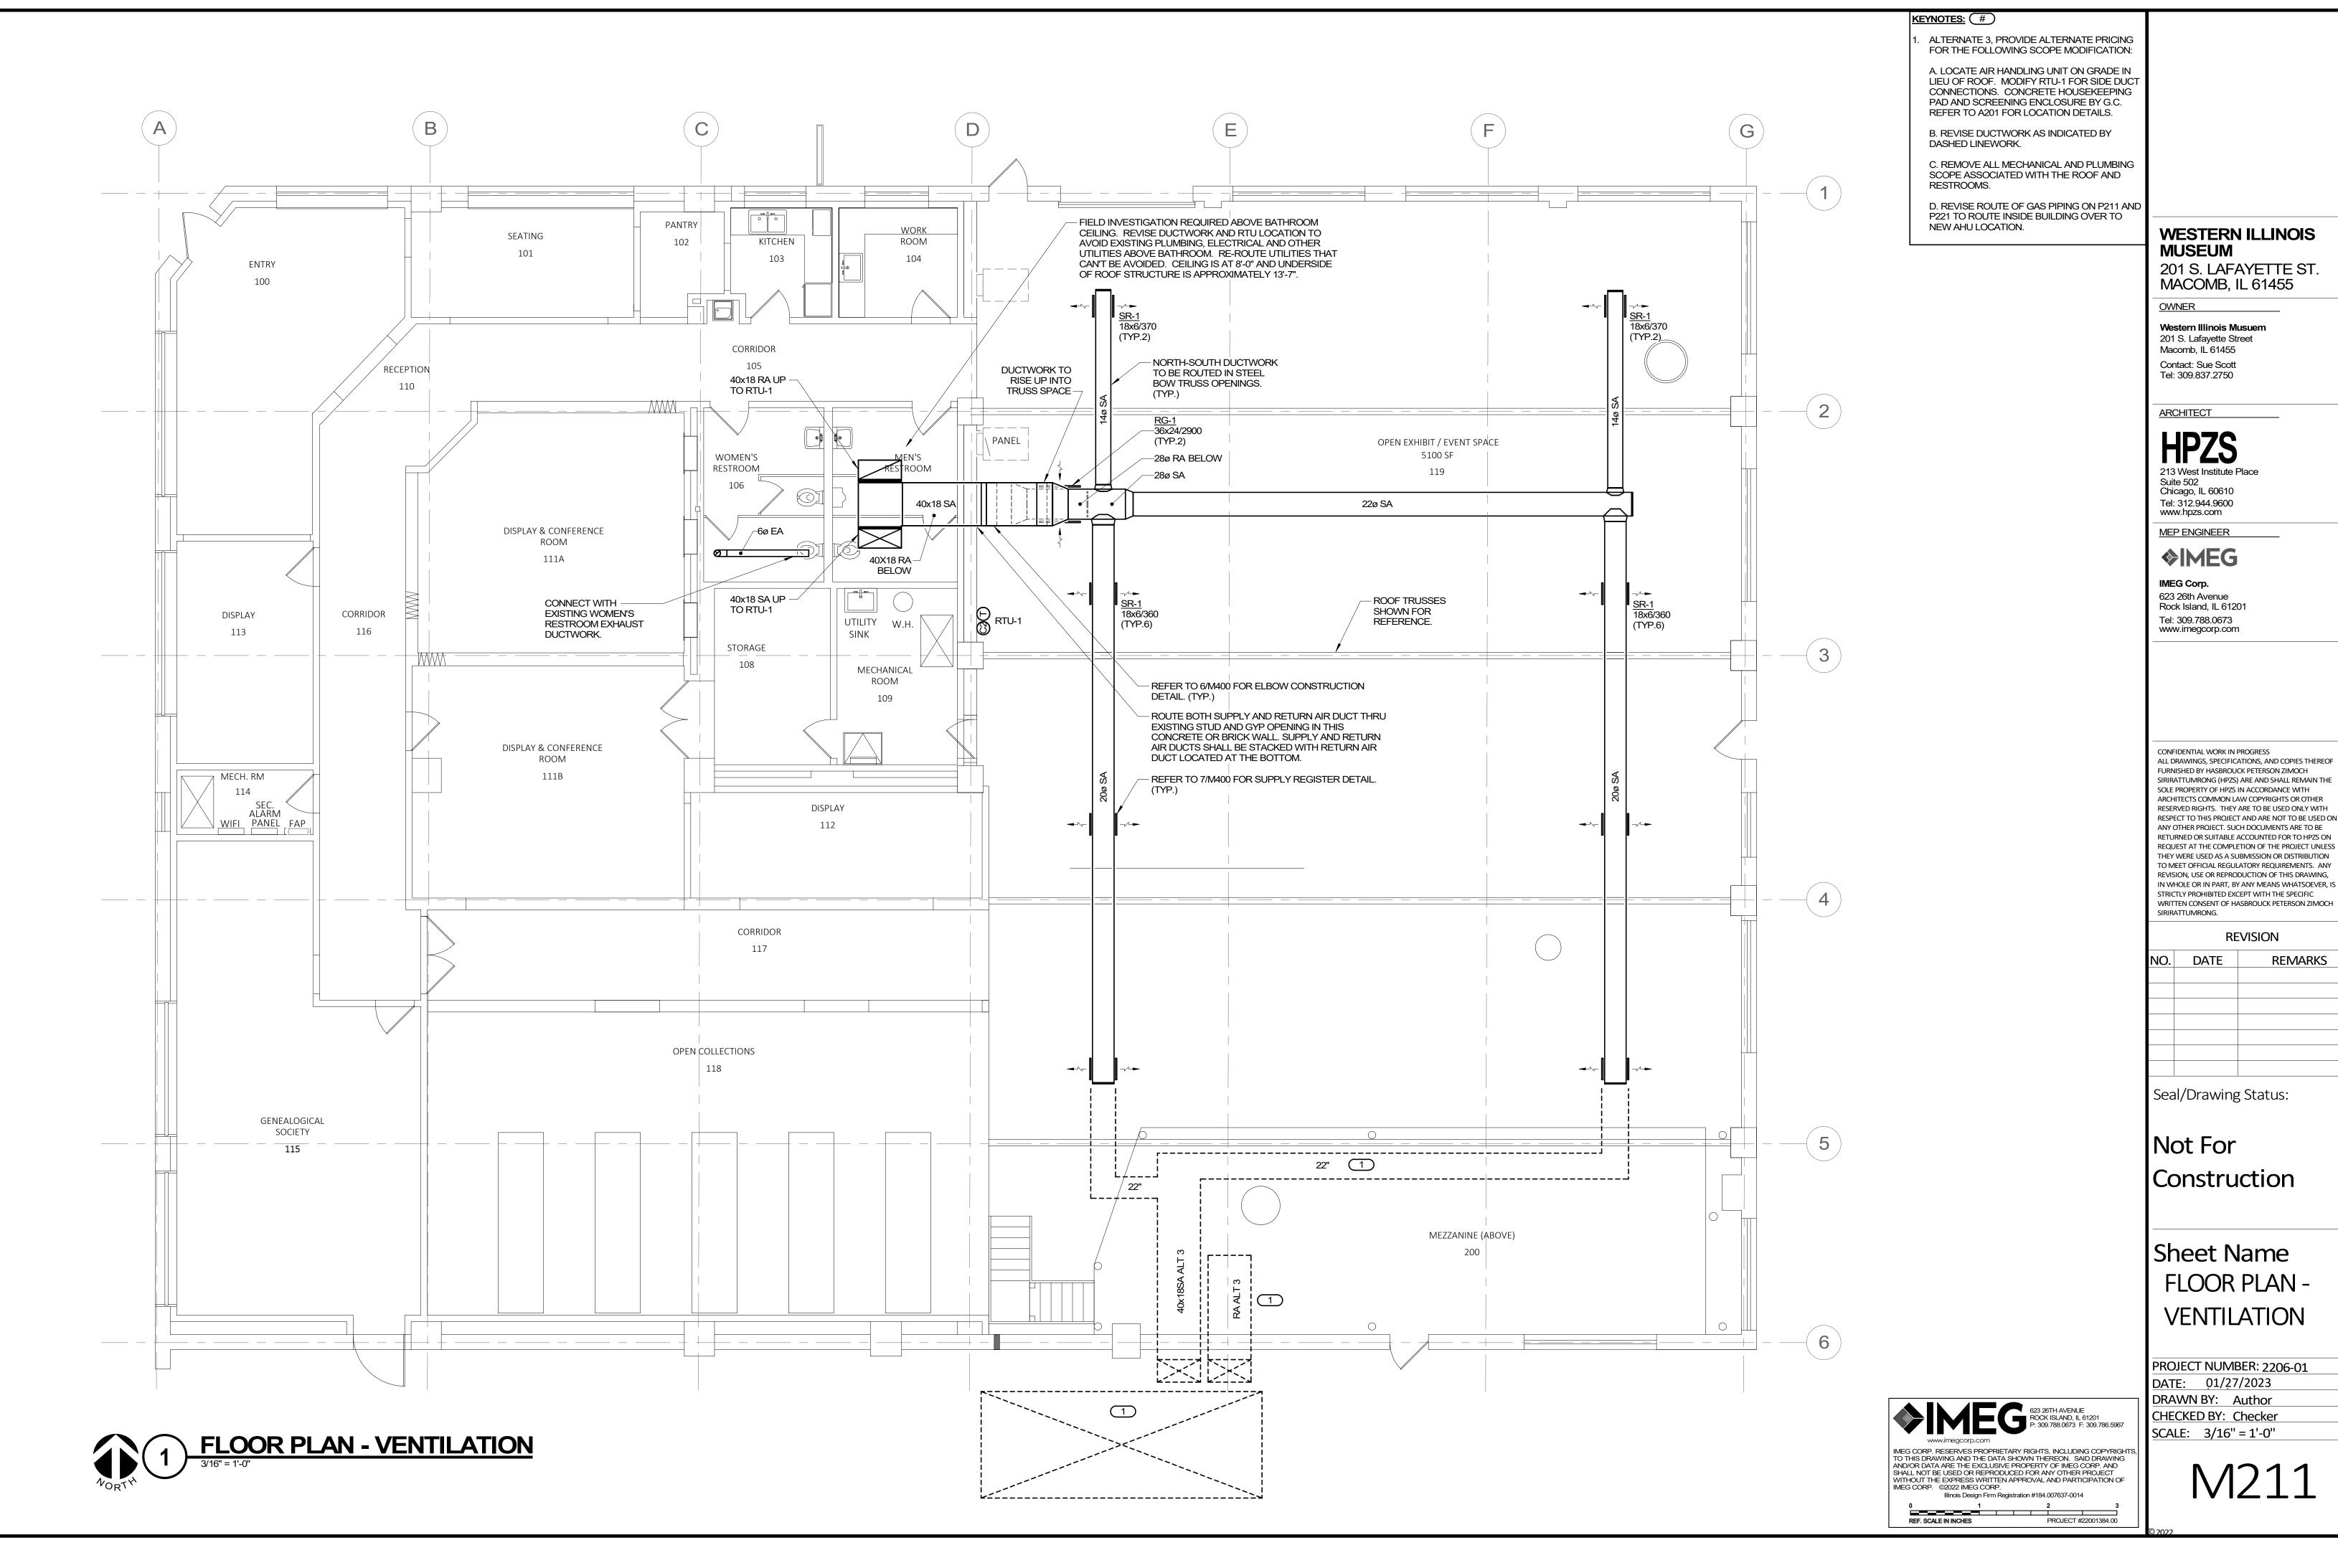

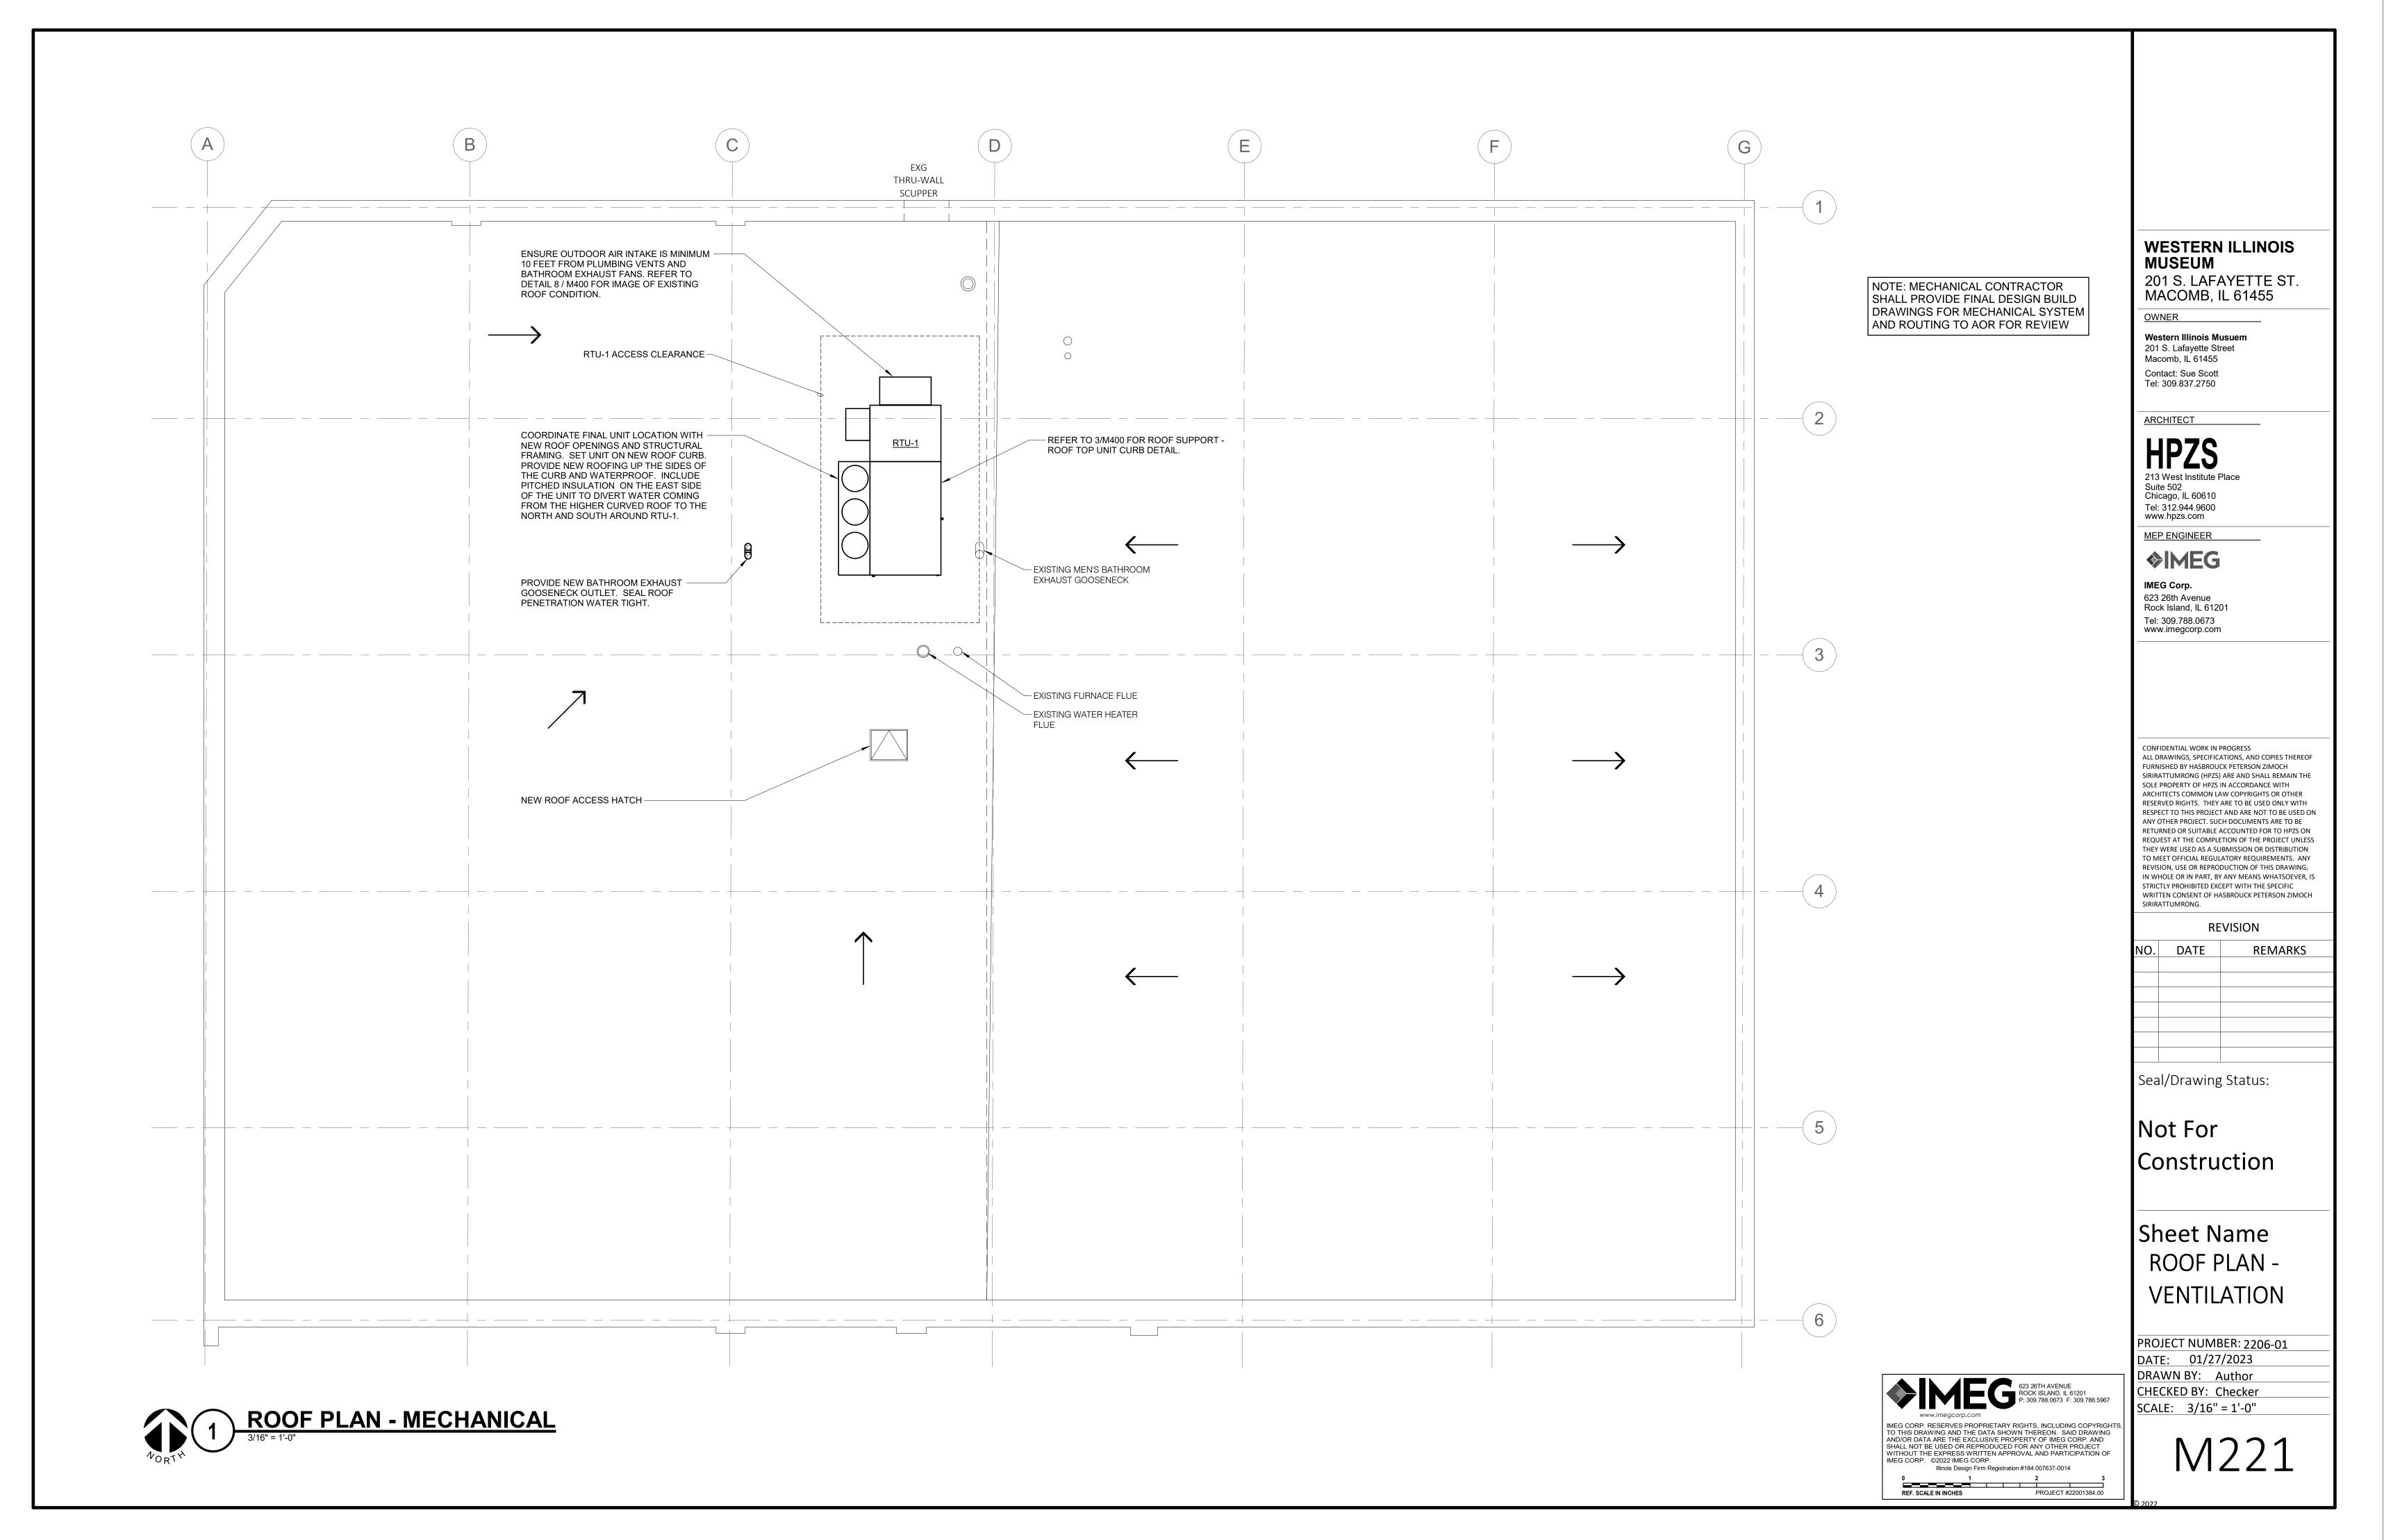

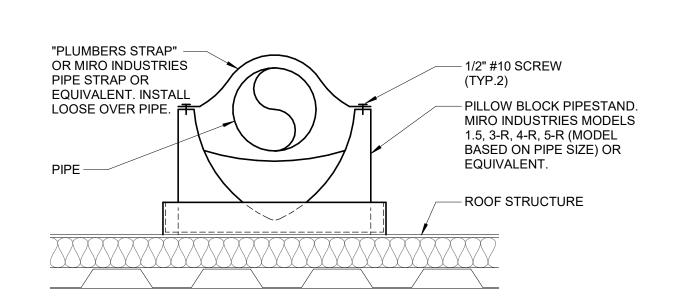

FULL SIZE CONDENSATE

MANUFACTURER.

DRAIN, CONNECT TO DRAIN


PAN AS RECOMMENDED BY

FLANGE BEFORE

**ASSEMBLY** 


- 1. SPACE STANDS AS REQUIRED TO MEET MANUFACTURERS
- RATED CAPACITIES. 2. COORDINATE PIPESTAND LOCATIONS WITH G.C.
- 3. PROVIDE EPDM PAD TO PROTECT ROOF IF REQUIRED BY
- ROOFING MANUFACTURER. 4. MIRO INDUSTRIES (800)768-6978.

# **ROOF SUPPORT - EXPOSED** PIPING PILLOW BLOCK NO SCALE

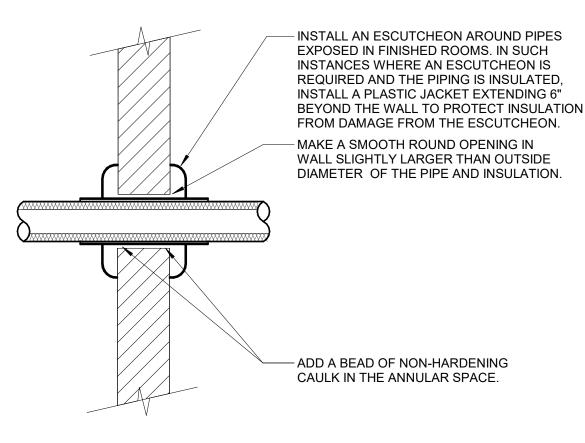

- 1. THIS DETAIL APPLIES TO ALL PIPES. THE INTENTION IS TO CONTINUE THE INSULATION AND VAPOR BARRIER THROUGH ALL PENETRATIONS. PERMIT THERMAL EXPANSION WITHOUT DAMAGING INSULATION, AND TO SEAL AIRTIGHT AROUND INSULATED AND UNINSULATED PIPES FOR NOISE
- TRANSMISSION CONTROL.
- 2. SEE SPECIFICATION SECTIONS (SECTION 22 05 29 PLUMBING SECTION 23 05 29 - HVAC) FOR ADDITIONAL INFORMATION.
- FLOOR OPENINGS ARE SIMILAR, SEE SPECIFICATION SECTION (SECTION 22 05 29 - PLUMBING, SECTION 23 05 29 - HVAC) FOR DIFFERENCES BETWEEN FLOOR AND WALL PENETRATIONS.

# WALL PENETRATION - NON-FIRE RATED NO SCALE

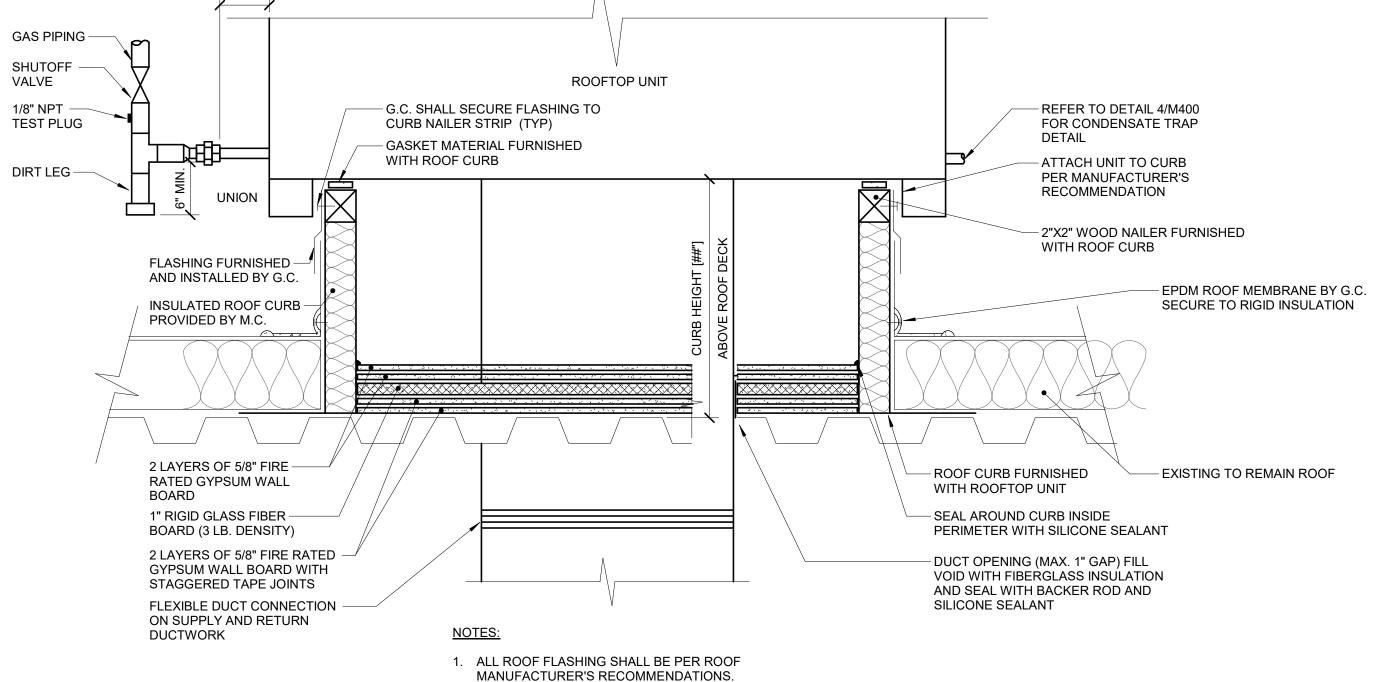

- 2. ROOF CURB SHALL BE INSTALLED PER ROOF CURB
- MANUFACTURER'S RECOMMENDATIONS.
- 3. PROVIDE EXTENDED CURB AS REQUIRED TO MAINTAIN 12"
- CLEARANCE ABOVE INSULATION.

# **ROOF SUPPORT - ROOF TOP UNIT CURB**

REFER TO STRUCTURAL SHEET S101 FOR STEEL SUPPORT DIAGRAM AT RTU-1; RTU-1 SHALL BE SUPPORTED BY ADDITIONAL FRAMING ATOP THE ROOF THAT MAY AFFECT THE DETAIL SHOWN HERE.

- STORM PIPE INSTALLED

**FERMINATE STORM** PIPE INTO TRENCH DOWNSPOUT BOOT

REMOVE CONCRETE

INCHES ON EITHER

INSTALL DRAIN AND

AROUND IT, FLUSH

SIDEWALK AND CURB.


POUR NEW CONCRETE

SIDE OF DRAIN.

WITH EXISTING

SIDEWALK AT LEAST 6

EXPOSED ON EXTERIOR

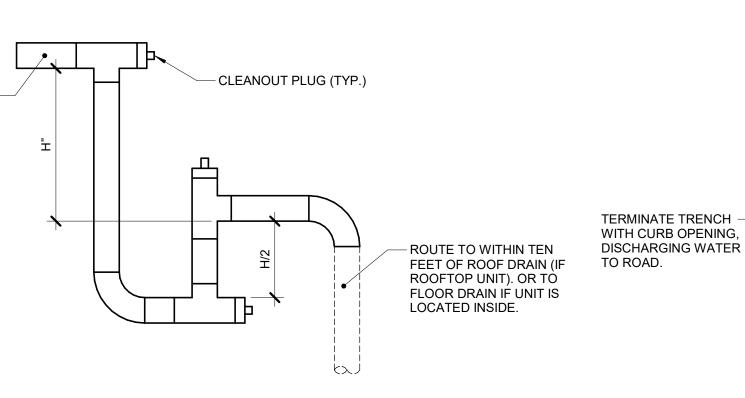

- SUPPLY REGISTER

- DAMPER ADJUSTMENT

- 1" DUCT LINER (TYP.)

(TYP.)


**CONDENSATE TRAP DETAIL** (DRAW-THROUGH)

**SUPPLY REGISTER DETAIL** 




NOTES: INCLUDE WITH ALTERNATE 1.


# TRENCH DRAIN AT SIDEWALK DETAIL NO SCALE

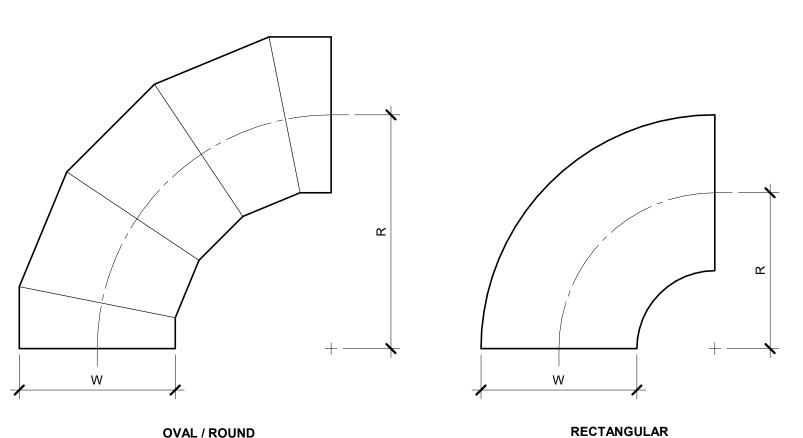

OVAL / ROUND **RADIUS ELBOW** SMOOTH OR 5 GORE (MINIMUM) R/W = 1.5 (MINIMUM)

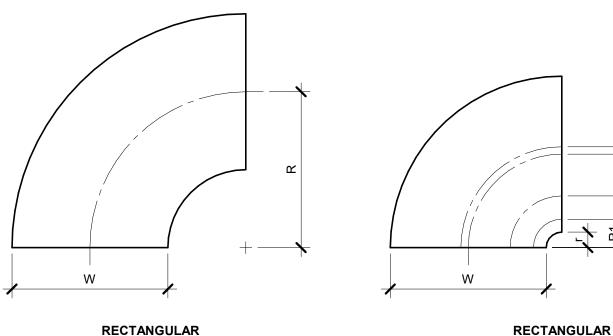

**RADIUS ELBOW** TYPE RE1 R/W = 1.0 (MINIMUM)R/W < 1.0 SHALL BE TYPE

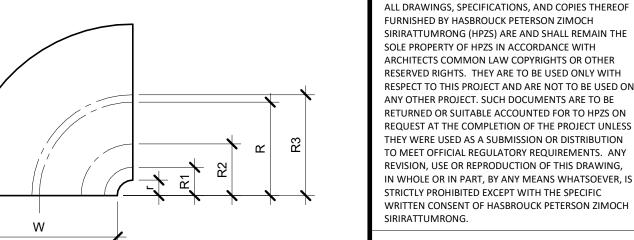

**RADIUS ELBOW WITH VANES** TYPE RE3

REFER TO SMACNA HVAC SYSTEMS DUCT DESIGN MANUAL FOURTH EDITION, SECTION 5.14 "SPLITTER VANES" AND SMACNA HVAC DUCT CONSTRUCTION STANDARDS, THIRD EDITION, FIGURES 4-2 AND 4-9 AND CHARTS 4-1 AND 4-1M. ELBOW SHALL HAVE THREE SPLITTER VANES AND r/W = 0.10 (R/W = 0.60) UNLESS NOTED OTHERWISE.

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DATE

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REMARKS

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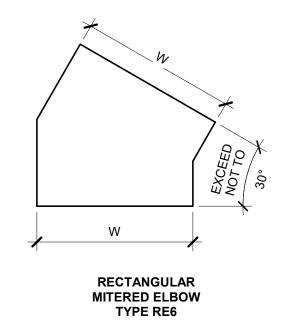
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Sheet Name **MECHANICAL** 


PROJECT NUMBER: 2206-01 DATE: 01/27/2023








USE ONLY AS PART OF OFFSETS AND TRANSITIONS PER FIGURE 4-7 TYPE 2 OR AS SHOWN ON DRAWINGS. OFFSETS ABOVE 30°

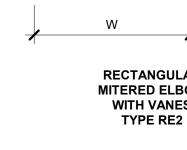

SHALL BE TYPE RE1.

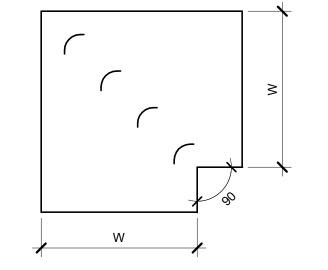

**RECTANGULAR** MITERED ELBOW WITH VANES

**RECTANGULAR / OVAL / ROUND MITERED ELBOW** WITHOUT VANES TYPE RE4

W

**NOT ALLOWED** 



- 1. BEAD, CROSSBREAK, AND REINFORCE FLAT SURFACES AS IN
- STRAIGHT DUCT. 2. REFER TO SPECIFICATIONS FOR ADDITIONAL INFORMATION. 3. DEFAULT ELBOW SHALL BE TYPE "RE1".
- 4. ELBOW TYPES SHALL BE INSTALLED AS SHOWN AND NOT BE SUBSTITUTED WITHOUT PERMISSION. EXCEPTION: RE1 OR RE3 MAY BE SUBSTITUTED FOR RE2.





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PLUMBING VENT TO BE RELOCATED.

BATHROOM EXHAUST

GOOSENECK TO BE

RELOCATED.

RECTANGULAR **RADIUS ELBOW WITH SQUARE THROAT** 

NOT ALLOWED

**DETAILS** 

DRAWN BY: Author CHECKED BY: Checker SCALE: 12" = 1'-0"

M400

#### PACKAGED ROOFTOP UNIT SCHEDULE – GAS-DX

NOTES: 1.POWER EXHAUST POWERED SEPARATELY.

2.TOTAL OPERATING WEIGHT INCLUDES UNIT, CURB, ACCESSORIES AND UNIT MOUNTED POWER EXHAUST. DUCT MOUNTED ACCESSORIES AND EQUIPMENT ARE NOT INCLUDED. CONTRACTOR IS RESPONSIBLE FOR ALL CHANGES REQUIRED DUE TO ROOFTOP UNIT HEAVIER THAN THE BASIS OF DESIGN AT NO ADDITIONAL COST. 3.PROVIDE SHAFT GROUNDING IF REQUIRED IN THE MOTOR SPECIFICATION 23 05 13.

3.PROVIDE SHAFT GROUNDING IF REQUIRED IN THE MOTOR SPECIFICATION 23 4.LAT LISTED IS AT LEAVING SIDE OF COOLING COIL.

5. PROVIDE PACKAGED ROOFTOP UNIT CONTROLS WITH UNIT BY MANUFACTURER. WIRE THERMOSTAT AS SHOWN ON FLOOR PLAN TO UNIT CONTROLS. NO EXISTING OR NEW BUILDING WIDE CONTROL SYSTEM.

			CFM)		SUPP	LY FAN (	(NOTE	3)				UNIT E	ELECTRI	CAL DATA	<u> </u>			СО	OLING	COIL -	DX			HEA	TING - (	GAS			РО	WERE	) EXHA	UST (NC	TE 1 AN	ND 3)		MAX	DIMENS	SIONS	WEIGHT (NOTE 2)			
TAG NAME	AREA SERVED	NOMINALTONS	MINIMUM OUTSIDE AIR (	NO. OF FANS	CFM TOTAL	EXT S.P. IN W.C.	RPM	ВНР ЕАСН	мнр еасн	VOLTAGE	PHASES	MOCP	BY (NOTE A)	TYPE (NOTE B)	CONTROL STARTER (NOTE A)	R(S)	EAT DB °F	EAT WB °F	LAT DB °F (NOTE 4)	LAT WB °F (NOTE 4)	SENSIBLE MBH	AMB TEMP °F	MIN EFF AFUE	MIN INPUT MBH	MIN OUTPUT MBH	TURN DOWN/STEPS	FUEL PRESSURE PSI	SEER (EER)	NO. OF FANS	CFM TOTAL	EXT S.P. IN W.C.	RPM	внр еасн	мнр еасн	CURB TYPE (NOTE G)	LENGTH	WIDTH	неіднт	UNIT WEIGHT	MANUFACTURER	MODEL	NOTES
RTU-1	OPEN EXHIBIT/EVENT SPACE	∃ 15	1600	1	5800	2.0	1718	5.4	7.5   2	208	3   11	1   150	MFR	NF	MFR	-	75.8   63	3.3   5	1.8	51.5 /	152 20	00   95	80	300	240	12:1	7   1	1.3 D	)   1	5,80	0.5	1396	2.84	5	MFR	163	98	76	4405	VALENT	VXE	

ENERGY	Y REC	OVE	ERY	SCH	lEDI	ULE																			
NOTES: 1.ENERGY REC	OVERY IS F	REQUES <sup>-</sup>	TED BY	OWNER	, CONFI	IRM IN C	D PHASI	E WHET	HER TO	INCLUDE	ENERGY I	RECOVE	ERY COM	/PONE	NTS WITI	HIN RTU	J BASED	ON COS	ST. OWI	NER MAY	ELECT TO OMIT ENE	RGY RECOVERY RE	QUIREMENT AT T	HAT TIME.	
			0	UTSIDE	SUPPLY	Y AIR ST	REAM						RI	ETURN/I	EXHAUS'	T AIR S	TREAM						ELEC	TRICAL	
			SUM	IMER			WIN	TER					SUM	IMER			WIN	NTER					DISCONNECT	CONTROLLER/ STARTER	
AIR HANDLING UNIT TAG NAME	CFM	EAT DB °F	EAT WB °F	LAT DB °F	LAT WB °F	EAT DB °F	EAT WB °F	LAT DB °F	LAT WB °F	APD	CFM	EAT DB °F	EAT WB °F	LAT DB °F	LAT WB °F	EAT DB °F	EAT WB °F	LAT DB °F	LAT WB °F	APD	RECOVERED SUMMER MBH	RECOVERED WINTER MBH	BY (NOTE A)	BY (NOTE A)	NOTES
RTU-1	1,600	95	78	77.7	65.5	-20	-20.6	57.2	46.9	0.25	1,600	75	62.4	91.9	75.5	72	55.7	-3.4	-3.4	0.25	81.36	133.402	MFR	MFR	

AIR T	ERMINAL	SCHEDULE									
2.REFER TO	O DRAWINGS FOR N	RMINE PROPER BORDER TY IECK SIZE. ALL BRANCH DUC ER ACCESSIBLE FROM GRIL	CTWORK TO AIR	R TERMINALS SH	IALL BE NEC	K SIZE UNLESS	NOTED OTHERWISE.				
TAG NAME	FACE SIZE (IN.) (NOTE 2)	TYPE	BORDER (NOTE 1)	MATERIAL	FINISH	VOLUME DAMPER REQUIRED	MANUFACTURER	MODEL		NOTES	
RG-1	INLET +2	PERFORATED FACE	1 1/4"	ALUMINUM	WHITE	NO	TITUS	S8F			
SR-1	INLET + 2	DOUBLE DEFLECTION	1 3/8"	ALUMINUM	WHITE	YES	TITUS	S300F	NOTE 3		

TAG NAME	DESCRIPTION	MANUFACTURER AND MODEL
TD-1	TRENCH DRAIN SYSTEM DESIGNED FOR INSTALLATION BELOW SIDEWALK WITH CURB OUTLET. ALL COMPONENTS TO BE POWDER COATED COLOR MATCHING EXISTING WINDOW TRIM.	EVERGRATE (T-08 SERIES) OF EQUAL.
	CAST IRON DOWNSPOUT BOOT. E66 SERIES, 6"X6" TOP BELL, 24" LENGTH WITH T-08C CONNECTION SIZE.	
	8"X6" STEEL TRENCH PAN WITH ANCHORING ANGLES AND CONTINUOUS 6" WIDE CAST IRON GRATE. STAINLESS STEEL GRATE SECURITY BOLTS. GRATE STYLE: CONTINUUM WITH 1/4" OPENINGS. EVERGRATE T-08C.	
	GREY IRON CURB OPENING. EVERGRATE C-846T.	

SCHEDULE GENERAL NOTES:
A. DISCONNECT AND CONTROLLER STARTER FURNISHED AND INSTALLED BY: MFR = MANUFACTURER EC = ELECTRICAL CONTRACTOR.
B. DISCONNECT TYPE: F = FUSED NF = NON-FUSED
C. CONTROLLER STARTER TYPE: FV = FULL VOLTAGE VFD = VARIABLE FREQUENCY DRIVE
D. FAN RPM SHALL NOT EXCEED 110% OF SCHEDULED VALUE, WITH THE SCHEDULED WHEEL TYPE. SUBSTITUTION OF BI OR BIA FANS FOR FC IS ACCEPTABLE IF EFFICIENCY IS NOT LOWER.
E. NO EQUIPMENT SHALL BE SELECTED ABOVE 90% OF MOTOR NAME PLATE RATING.
F. MUST BE WITHIN +/- 10% OF SCHEDULED RPM.
G. CURB TYPE:  MFR = STANDARD CURB BY MANUFACTURER  GC = BY GENERAL CONTRACTOR

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Sheet Name MECHANICAL SCHEDULES

PROJECT NUMBER: 2206-01


DATE: 01/27/2023

DRAWN BY: Author

CHECKED BY: Checker

SCALE:

M600

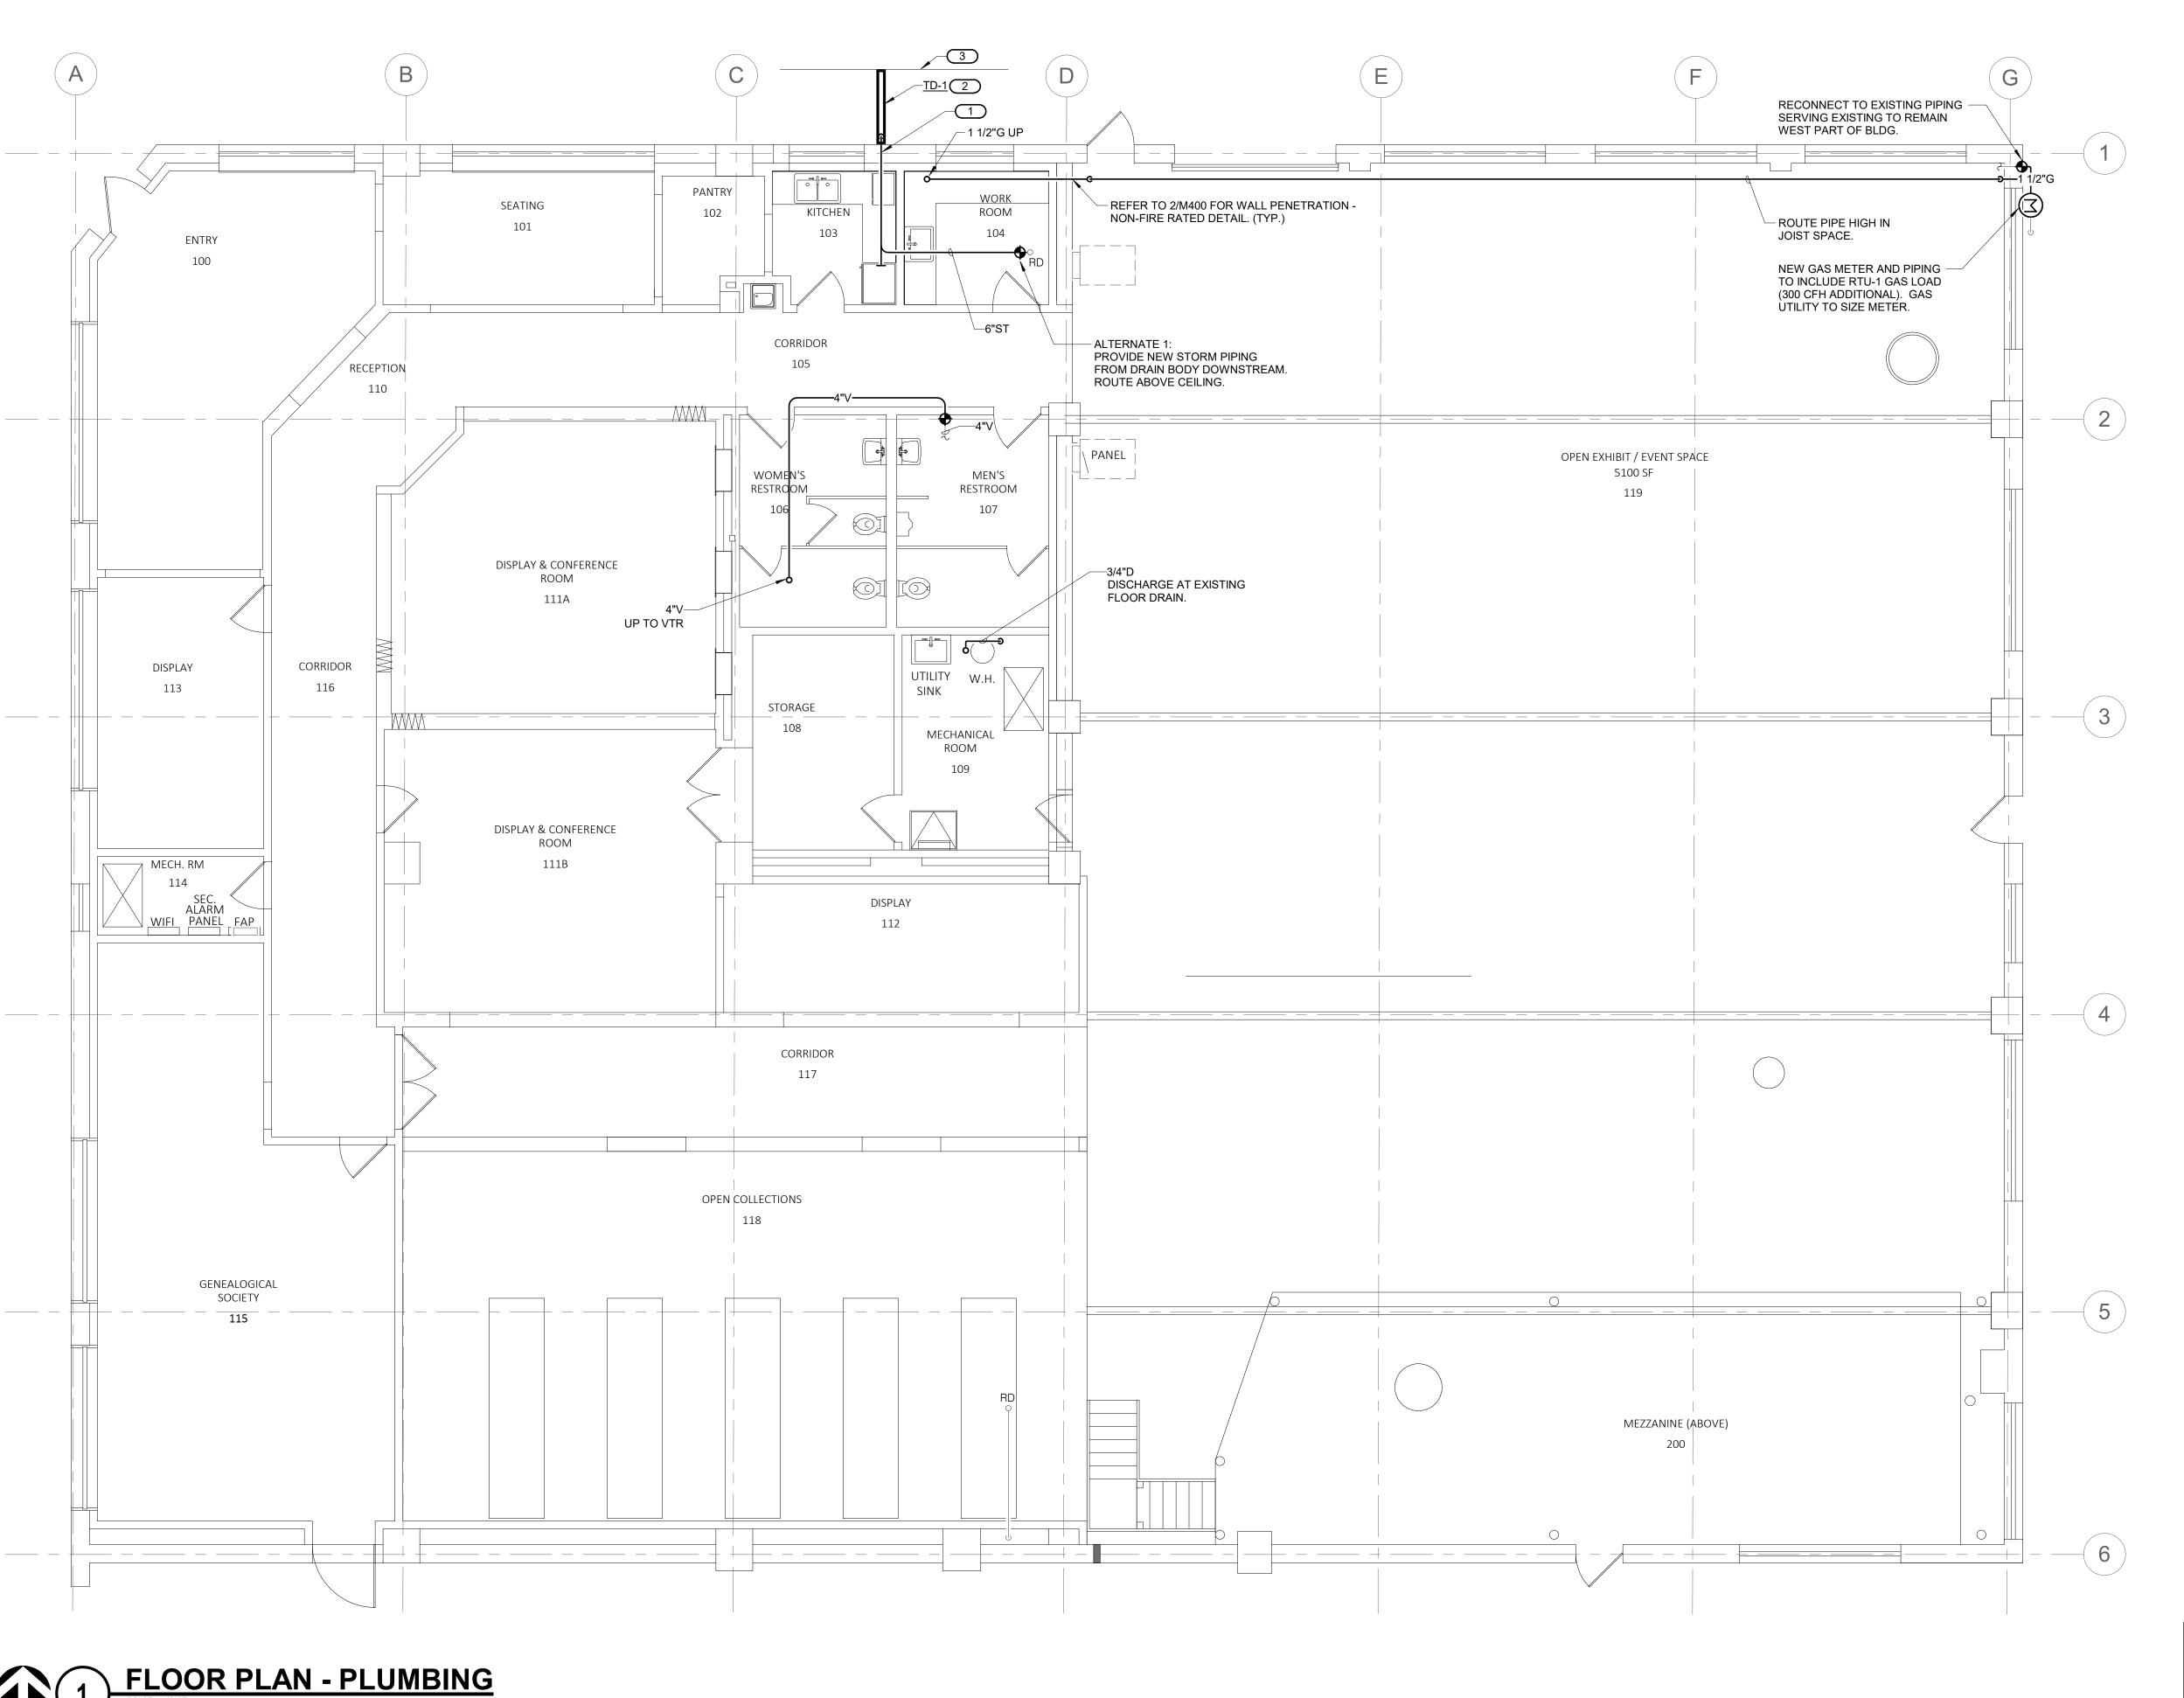

KEYNOTES: #

1. ALTERNATE 1, PROVIDE NEW HOLE IN EXTERIOR WALL, SEAL PENETRATION WATER TIGHT. ROUTE 6"ST DOWN EXPOSED ON WALL PAINT TO MATCH WINDOW TRIM COLOR. TERMINATE INTO TRENCH BOOT ASSEMBLY.

2. ALTERNATE 1, REFER TO DETAIL 5/M400.

3. EXISTING CURB TRANSITION FROM SIDEWALK TO ROAD.

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Sheet Name FLOOR PLAN -PLUMBING

PROJECT NUMBER: 2206-01

DATE: 01/27/2023

DRAWN BY: Author

CHECKED BY: Checker

SCALE: 3/16" = 1'-0"

P211


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**ROOF PLAN - PLUMBING** 

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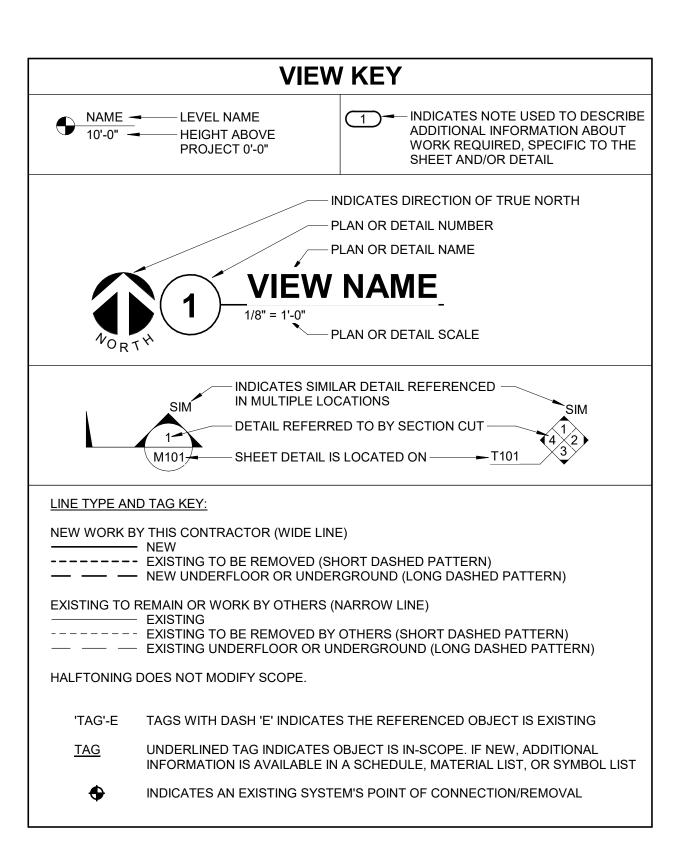
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APPLIC	CABLE CODES
CONTRACTOR SHALL COMPLY WITH	H APPLICABLE CODES AND LOCAL AMENDMENTS.
BUILDING CODE:	IBC 2018 EDITION
FIRE CODE:	IFC 2018 EDITION
PLUMBING CODE:	ILLINOIS PLUMBING CODE
MECHANICAL CODE:	IMC 2018 EDITION
ELECTRICAL CODE:	NFPA 70 (NEC) 2020 EDITION
LIFE SAFETY CODE:	NFPA 101 CURRENT EDITION
ENERGY CONSERVATION CODE:	IECC 2018
LOCAL BUILDING CODE:	CURRENT EDITION

	CONTRACTOR ABBREVIATION KEY
ABBR:	DESCRIPTION:
E.C.	ELECTRICAL CONTRACTOR
M.C.	MECHANICAL CONTRACTOR

CONTACT PERSONS:	
DESCRIPTION:	PERSON:
PROJECT MANAGER	MATT SNYDER
MECHANICAL	ERIC BUSCH
ELECTRICAL	ADAM BROCKMAN

ELECTRICAL SHEET INDEX		
E000	ELECTRICAL COVERSHEET	
E101	FLOOR PLAN DEMOLITION - ELECTRICAL	
E221	FLOOR PLAN - ELECTRICAL	
E241	ROOF PLAN - ELECTRICAL	
E500	ELECTRICAL DIAGRAMS	
GRAND TOTAL: 5		

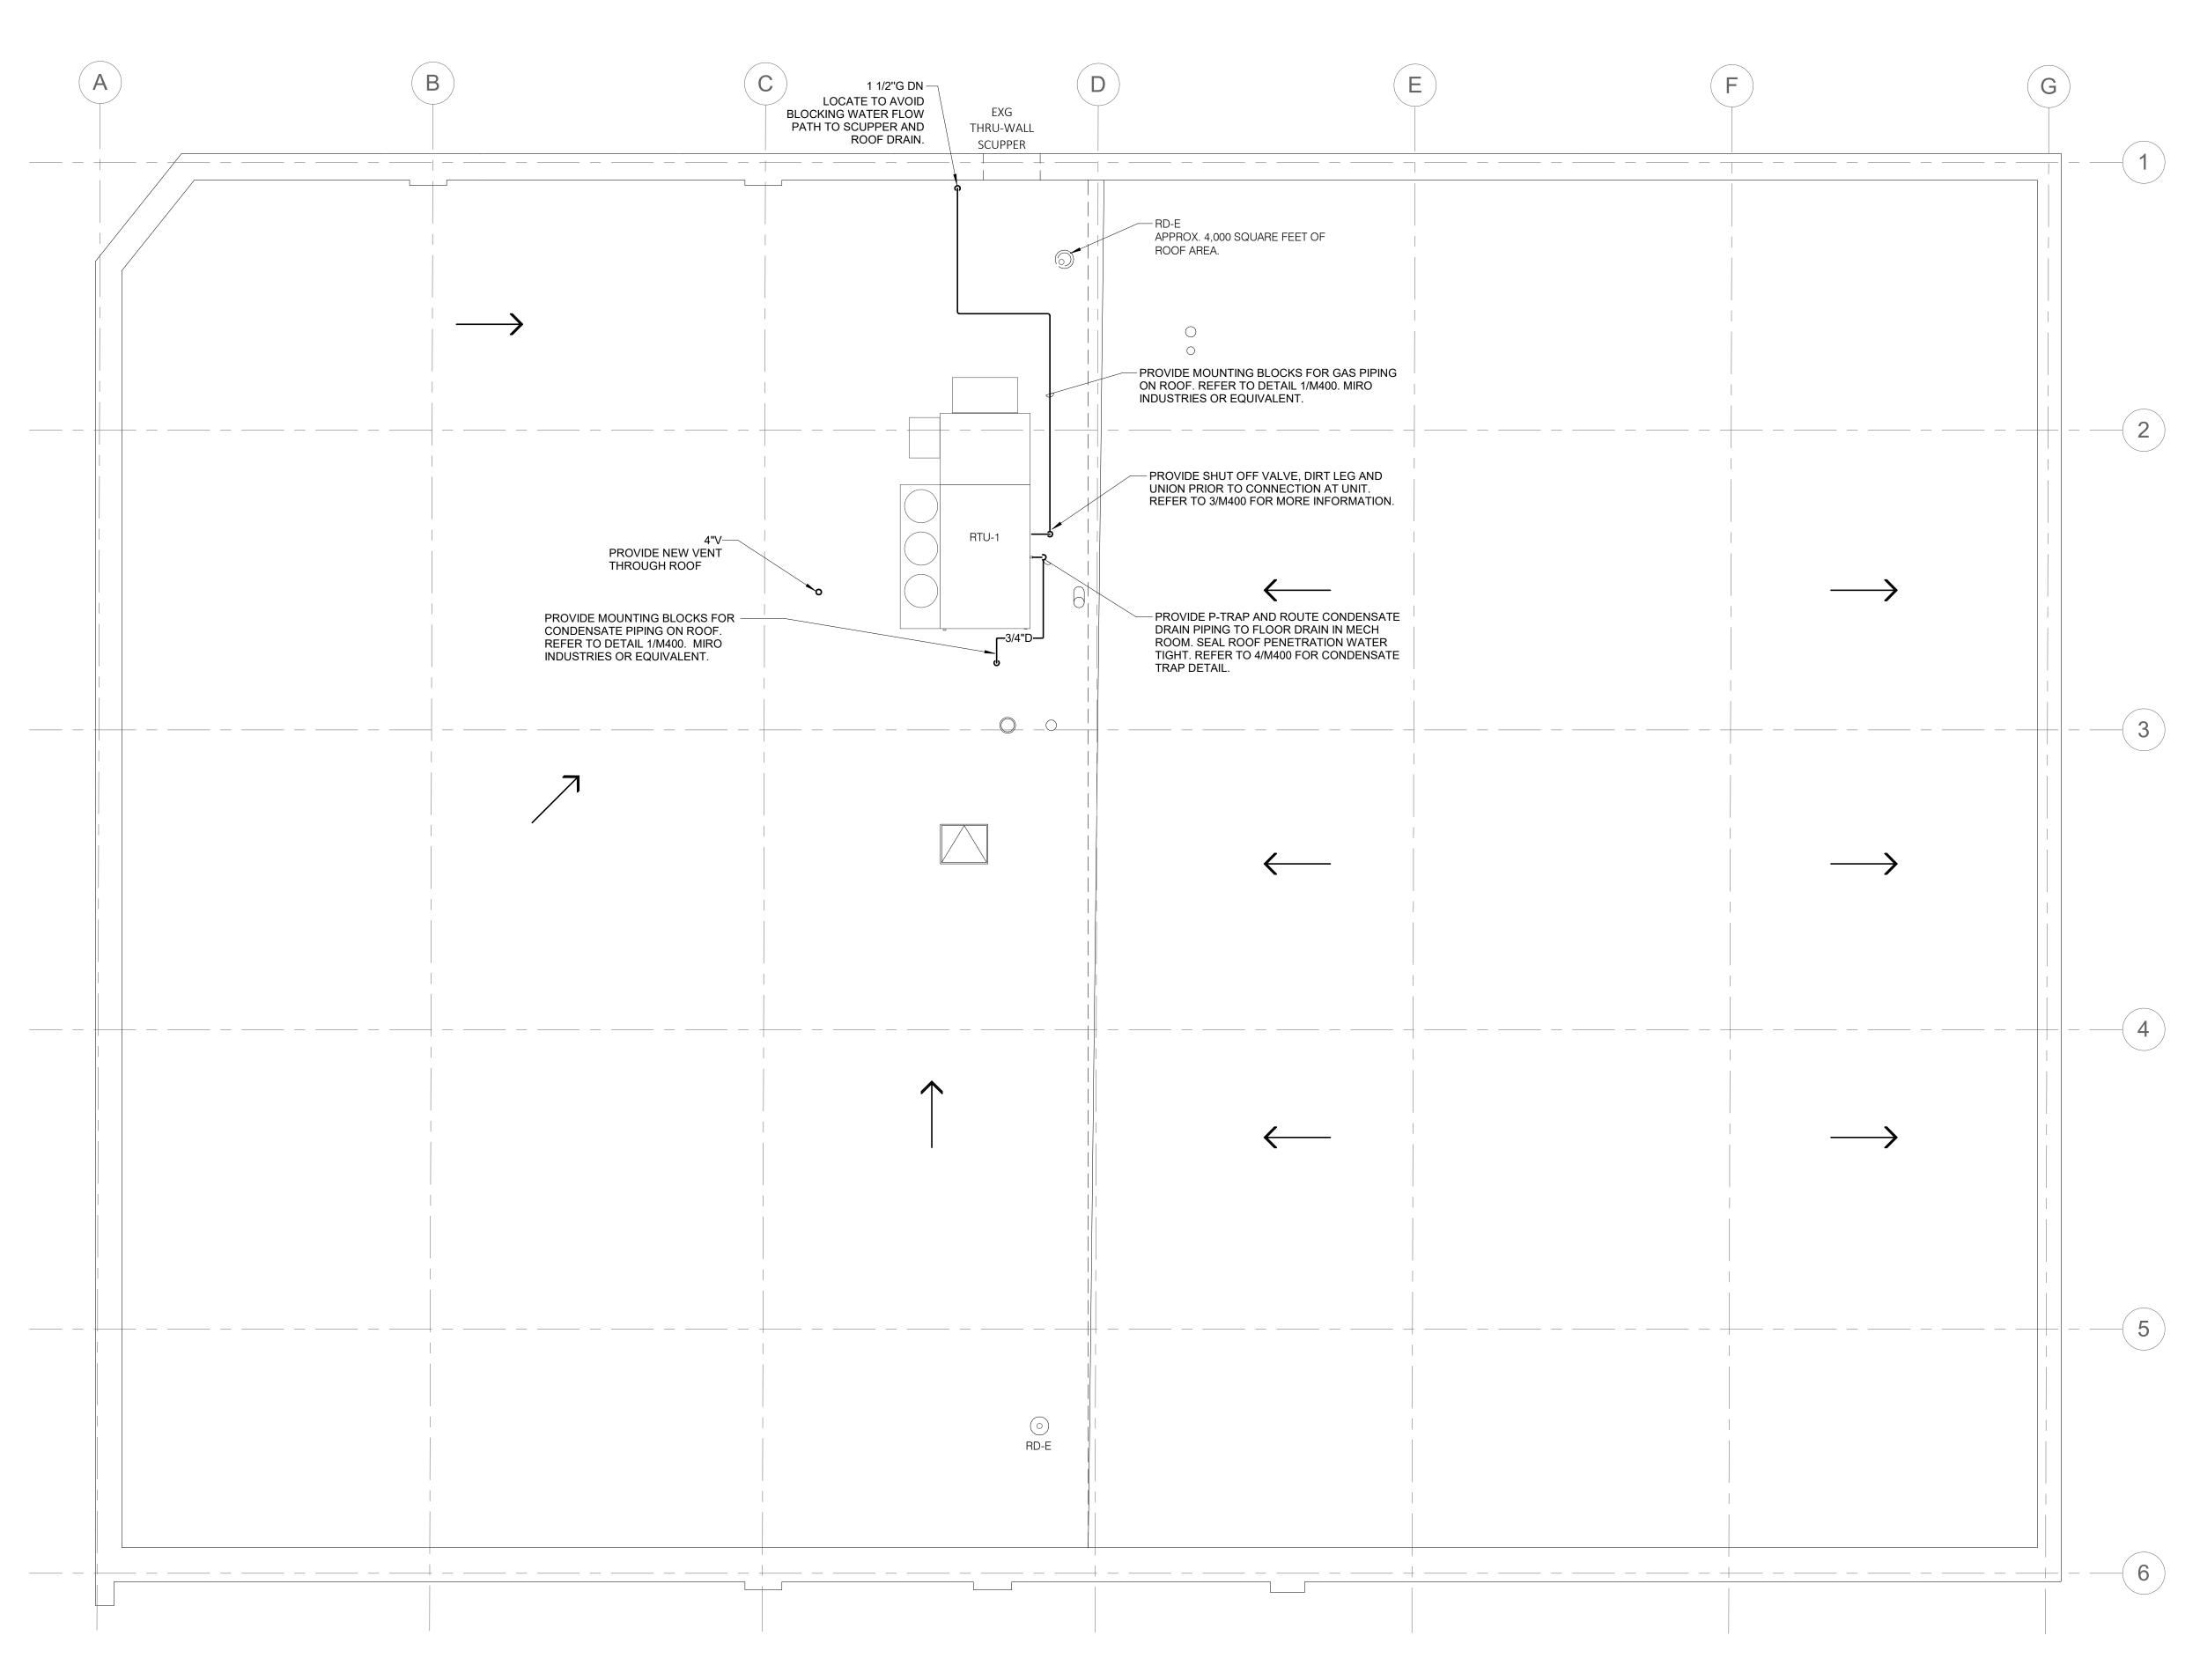ELECTRICAL SYMBOL LIST		
SYMBOL:	TAG:	DESCRIPTION:
E	<u>ECONN</u>	ELECTRICAL CONNECTION
	PANEL '###'	PANELBOARD - SURFACE MOUNT

ELECTRICAL SYMBOL LIST		
SYMBOL:	TAG:	DESCRIPTION:
<sub>W</sub> ₩	REC-DUP-WP	DUPLEX GFI WEATHERPROOF RECEPTACLE 125V

ELECT	ELECTRICAL SYMBOL LIST	
SYMBOL:	DESCRIPTION:	
	LINEAR LUMINAIRES	
	TROFFER	
••••	DOWNLIGHT LUMINAIRE INDUSTRIAL LUMINAIRE	
	SINGLE FACE EXIT SIGN	
4	EMERGENCY UNIT	

ELECTRICAL ABBREVIATION KEY		
ABBR: DESCRIPTION:		
AFF	ABOVE FINISHED FLOOR	
С	CONDUIT	
GFI	GROUND FAULT INTERRUPTER	
TYP	TYPICAL	
UON	UNLESS OTHERWISE NOTED	

ELE	ELECTRICAL SYMBOL LIST		
SYMBOL:	TAG:	DESCRIPTION:	
(S)#	FA-120	FIRE ALARM SMOKE DETECTOR, CEILING OR WALL MOUNT	
\(\s\)	<u>FA-122</u>	FIRE ALARM DUCT SMOKE DETECTOR # = EQUIP OR SYSTEM	
<b>□ □ □ □</b>	<u>FA-121</u>	GAS DETECTION, CEILING OR WALL MOUNT CO = CARBON MONOXIDE	
RI	FA-241	FIRE ALARM REMOTE INDICATOR	
СМ	<u>FA-161</u>	FIRE ALARM ADDRESSABLE CONTROL MODULE BLANK = REFER TO PLANS	

CONDUIT INSTALLATION SCHEDULE

THE FOLLOWING SCHEDULE SHALL BE ADHERED TO UNLESS THEY OF VIOLATION OF APPLICABLE CODES OR ARE NOTED OTHERWISE ON THE INSTALLATION OF RMC CONDUIT WILL BE PERMITTED IN PLACE OF A SPECIFIED IN THIS SCHEDULE.	THE DRAWIN	
INSTALLATION TYPE	RMC	EMT
FEEDERS: SWITCHBOARDS, DISTRIBUTION PANELS, PANELBOARDS, MOTOR CONTROL CENTERS, ETC.		Х
BRANCH CIRCUITS: LIGHTING, RECEPTACLES, CONTROLS, ETC.		Х
MECHANICAL EQUIPMENT FEEDERS: PUMPS, CHILLERS, AIR HANDLING UNITS, ETC.		Х
FLOOR MOUNTED EQUIPMENT FEEDERS: PUMPS, ETC. (INCLUDE NO MORE THAN 6 FEET OF LFMC TO PUMP)		х
CONTROLS (LIGHTING, POWER, BUILDING AUTOMATION, ETC.)		X
FINISHED SPACES / CONCEALED		X
WET AND DAMP LOCATIONS: (CONDUIT, BOXES, FITTINGS, INSTALLED AND EQUIPPED TO PREVENT WATER ENTRY)	х	
INTERIOR LOCATIONS: CONCEALED		X
INTERIOR LOCATIONS: EXPOSED		Х
INTERIOR LOCATIONS: EXISTING WALLS AND EXPOSED INSTALLATION (FINISHED SPACES)		Х

#### SERVICE ENTRANCE − #2/0 GROUNDING ELECTRODE **EQUIPMENT** REMOVABLE LINK -CONDUCTOR PER NEC 250.66 NEUTRAL GROUND - EFFECTIVELY GROUNDED BUILDING STEEL CONNECT TO METALLIC WATER MAIN, WITHIN 5'-0" OF WATER SERVICE ENTRANCE S-MWWM **ELECTRICAL GROUND** PROVIDE JUMPER FIELD. 3/4" DIA. x 10'-0" ACROSS WATER METER COPPER GROUND ROD.

TOP OF ROD SHALL BE 12"

BELOW GRADE.

#### **ELECTRICAL RENOVATION NOTES:**

- THESE NOTES APPLY TO ALL ELECTRICAL SHEETS AND TRADES, INCLUDING BUT NOT LIMITED TO, LIGHTING, POWER, AND SYSTEMS.
- 1. EXISTING CONDITIONS ARE SHOWN BASED ON INFORMATION OBTAINED FROM FIELD SURVEYS, EXISTING BUILDING DOCUMENTS, AND STAFF. VERIFY EXISTING CONDITIONS AND
- REPORT ANY CONFLICTS BEFORE PROCEEDING. 2. NOT ALL EXISTING EQUIPMENT, LUMINAIRES, AND CONDUIT ARE SHOWN. VERIFY EXISTING
- CONDITIONS AND REPORT ANY CONFLICTS WITH NEW WORK BEFORE STARTING WORK. 3. FIELD VERIFY THE AVAILABLE CLEARANCES FOR CABLE TRAY, BUSWAY AND CONDUITS BEFORE FABRICATION. RISES AND DROPS MAY BE NECESSARY BECAUSE OF EXISTING
- 4. EACH CONTRACTOR SHALL FIELD VERIFY ACCESSIBILITY TO THE AREA OF THEIR WORK AND SHALL NOTIFY THE GENERAL CONTRACTOR PRIOR TO BIDDING IF OTHER UTILITIES ARE
- REQUIRED TO BE REMOVED OR RELOCATED TO ALLOW ACCESS TO THEIR AREA OF WORK. 5. THE GENERAL CONTRACTOR IS RESPONSIBLE FOR CUTTING, REMOVAL AND PATCHING OF ROOFS, WALLS, AND FLOORS ASSOCIATED WITH WORK BY ALL CONTRACTORS.
- CONTRACTORS SHALL NOTIFY THE GC OF AFFECTED AREAS PRIOR TO BIDDING. 6. THE GENERAL CONTRACTOR IS RESPONSIBLE FOR REMOVAL AND REPLACEMENT OF CEILINGS, CEILING TILES, AND CEILING GRIDS ASSOCIATED WITH AREAS OF WORK BY ALL CONTRACTORS. NOTIFY THE GENERAL CONTRACTOR OF AFFECTED AREAS PRIOR TO
- 7. WHERE EXISTING ELECTRICAL SYSTEMS ARE LOCATED IN AREAS THAT CONFLICT WITH NEW EQUIPMENT, PIPING, OR DUCTWORK TO BE INSTALLED, EACH CONTRACTOR SHALL EITHER ARRANGE NEW EQUIPMENT, CONDUIT, OR DUCTWORK IN SUCH A FASHION THAT IT DOES NOT CONFLICT WITH EXISTING SYSTEMS, OR REWORK EXISTING ELECTRICAL SYSTEMS TO ALLOW FOR INSTALLATION OF NEW EQUIPMENT, PIPING, OR DUCTWORK.
- EXISTING EMERGENCY LIGHTING AND EXIT SIGNAGE SHALL REMAIN. 9. THE COMPLETE INSTALLATION SHALL BE IN ACCORDANCE WITH THE ADA STANDARDS FOR ACCESSIBLE DESIGN. REFER TO THE ADA GUIDELINES FOR ALL CONFIGURATION DETAILS
- ON THIS PAGE FOR ADDITIONAL INFORMATION. 10. MOUNT EXTERIOR LOCATED RECEPTACLES WITH WHILE-IN-USE COVERS AT +20" FROM
- FINISHED GRADE (CENTER DIMENSIONS) TO MAINTAIN INSTALLATION ADA COMPLIANCE. 11. ALL MATERIALS USED TO SEAL PENETRATIONS OF FIRE RATED WALLS AND FLOORS SHALL BE TESTED AND CERTIFIED AS A SYSTEM PER ASTM E814 STANDARDS FOR FIRE TESTS OF THROUGH-PENETRATION FIRESTOPS.


### **ELECTRICAL GENERAL NOTES:**

DEVICE KEY: A = MOUNTING (IF APPLICABLE)

\*IF LABEL IS ORIENTED HORIZONTALLY A SLASH WILL SEPARATE THIS

INFORMATION. EX: A / 1

# SERVICE ENTRANCE GROUNDING ELECTRODE SYSTEM DETAIL

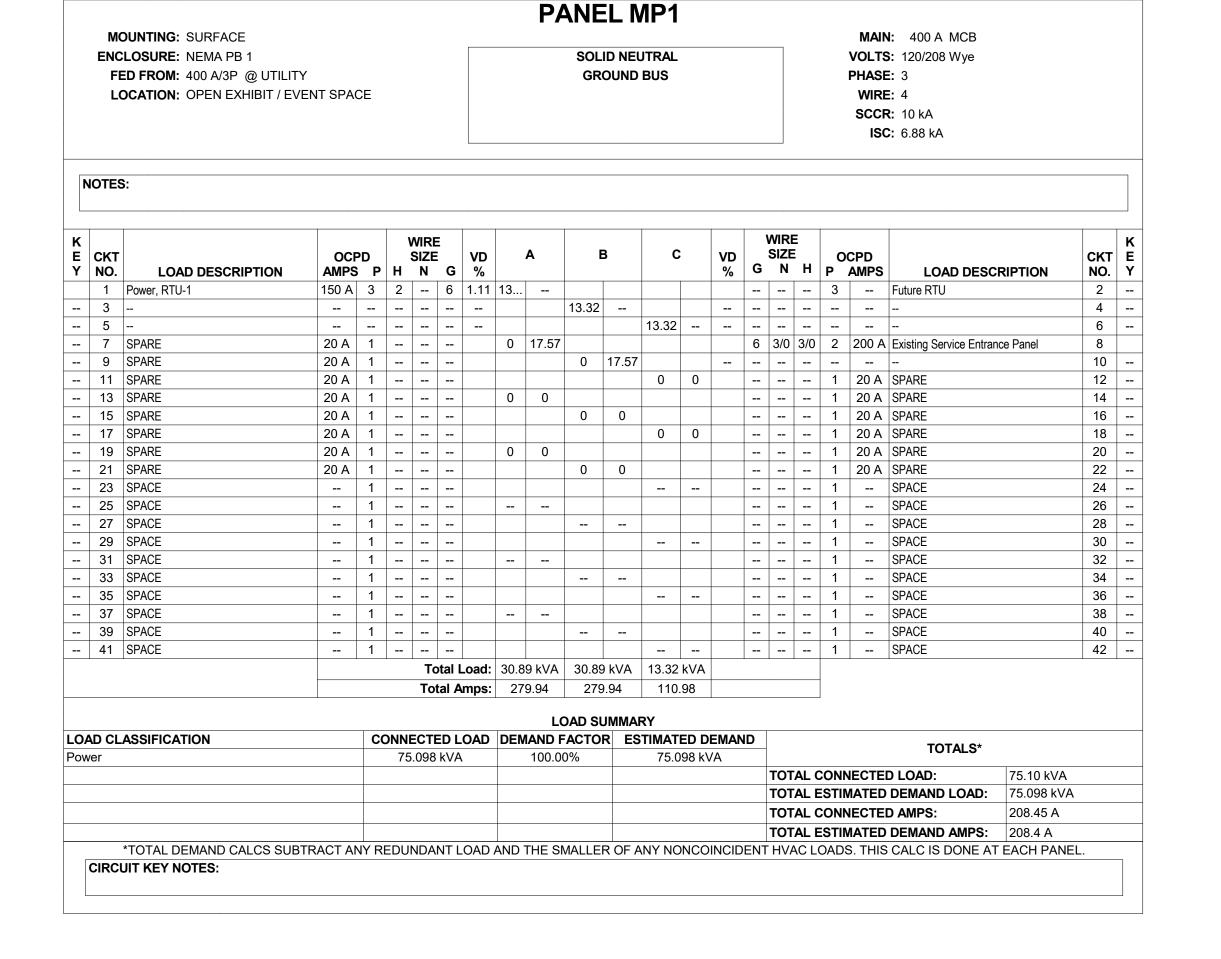



Illinois Design Firm Registration #184.007637-0014 

PROJECT #22001384.00

MUSEUM 201 S. LAFAYETTE ST MACOMB, IL 61455

**WESTERN ILLINOIS** 

Western Illinois Musuem 201 S. Lafayette Street Macomb, IL 61455 Contact: Sue Scott

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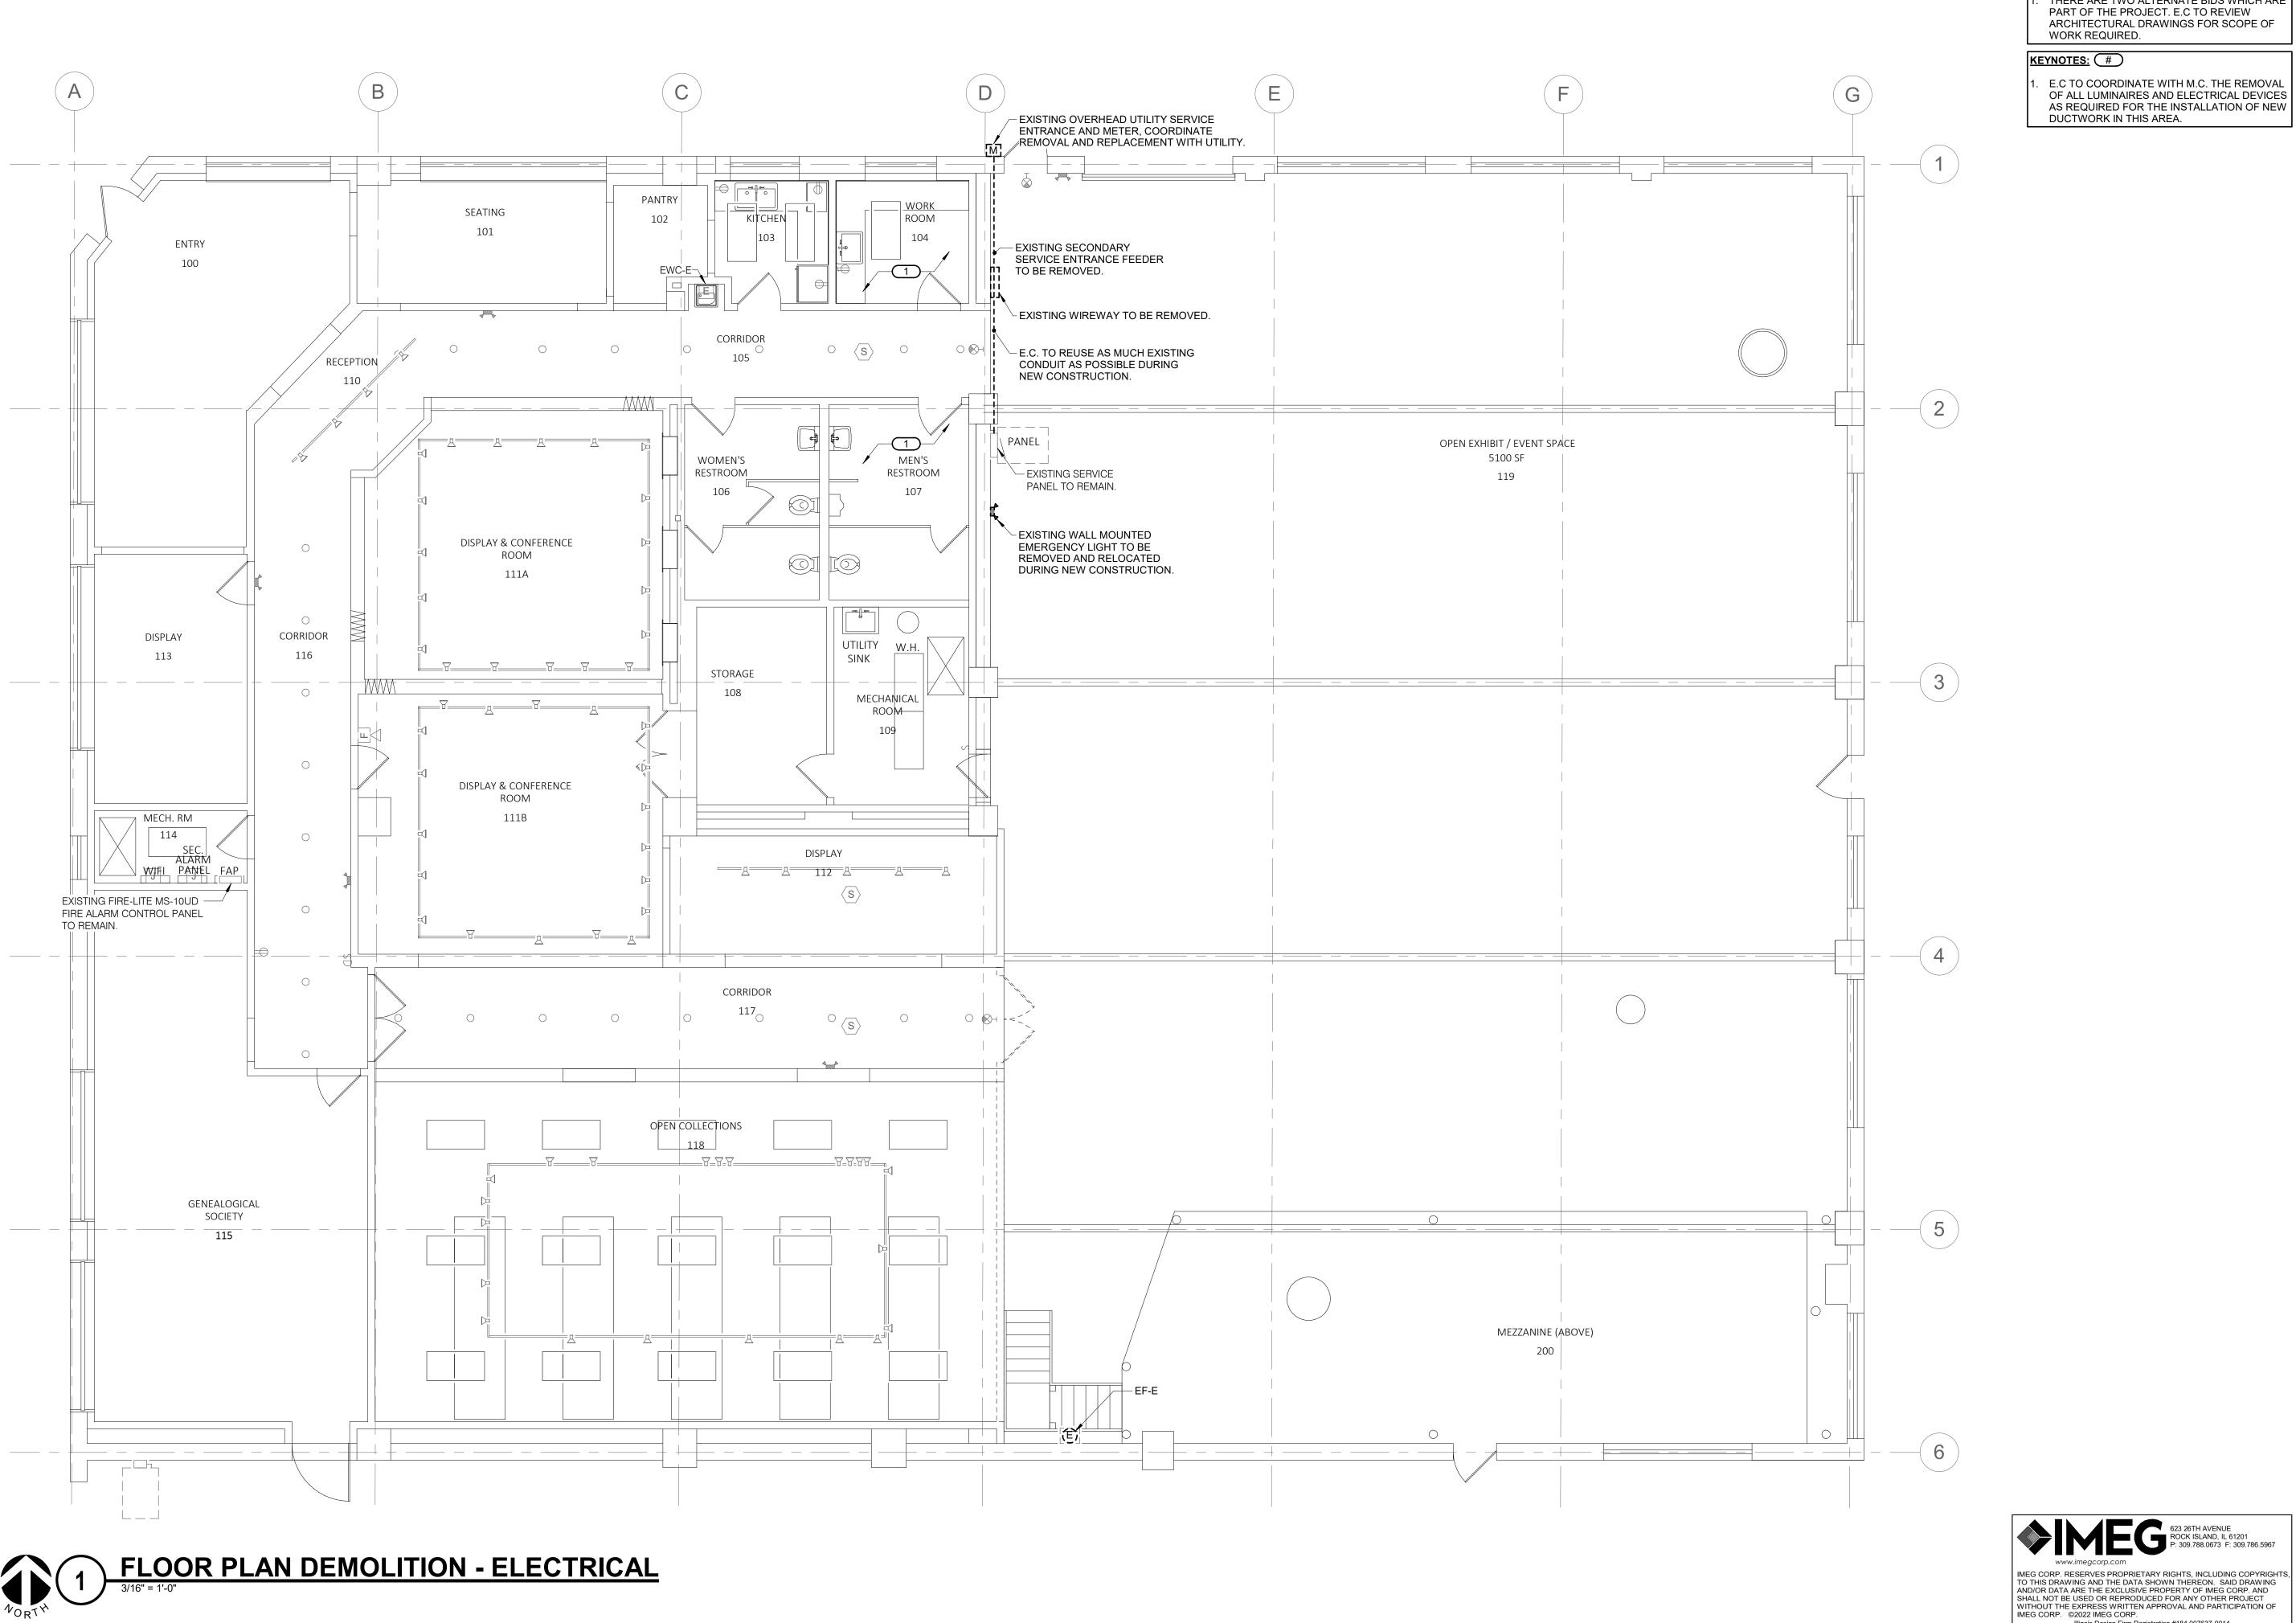
	REVISION	
NO.	DATE	REMARKS

Seal/Drawing Status:

Not For Construction

Sheet Name **ELECTRICAL** COVERSHEET

PROJECT NUMBER: 2206-01 DATE: 01/27/2023 DRAWN BY: ADABRO **CHECKED BY: Checker** SCALE: As indicated



#### SHEET NOTES:

THERE ARE TWO ALTERNATE BIDS WHICH ARE PART OF THE PROJECT. E.C TO REVIEW ARCHITECTURAL DRAWINGS FOR SCOPE OF WORK REQUIRED.

#### KEYNOTES: #

E.C TO COORDINATE WITH M.C. THE REMOVAL OF ALL LUMINAIRES AND ELECTRICAL DEVICES AS REQUIRED FOR THE INSTALLATION OF NEW DUCTWORK IN THIS AREA.

#### **WESTERN ILLINOIS MUSEUM**

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NO.	DATE	REMARKS

Seal/Drawing Status:

Not For Construction

Sheet Name FLOOR PLAN **DEMOLITION -**


ELECTRICAL PROJECT NUMBER: 2206-01

DATE: 01/27/2023 DRAWN BY: ADABRO CHECKED BY: Checker SCALE: 3/16" = 1'-0"

Illinois Design Firm Registration #184.007637-0014

REF. SCALE IN INCHES PROJECT #22001384.00

E101

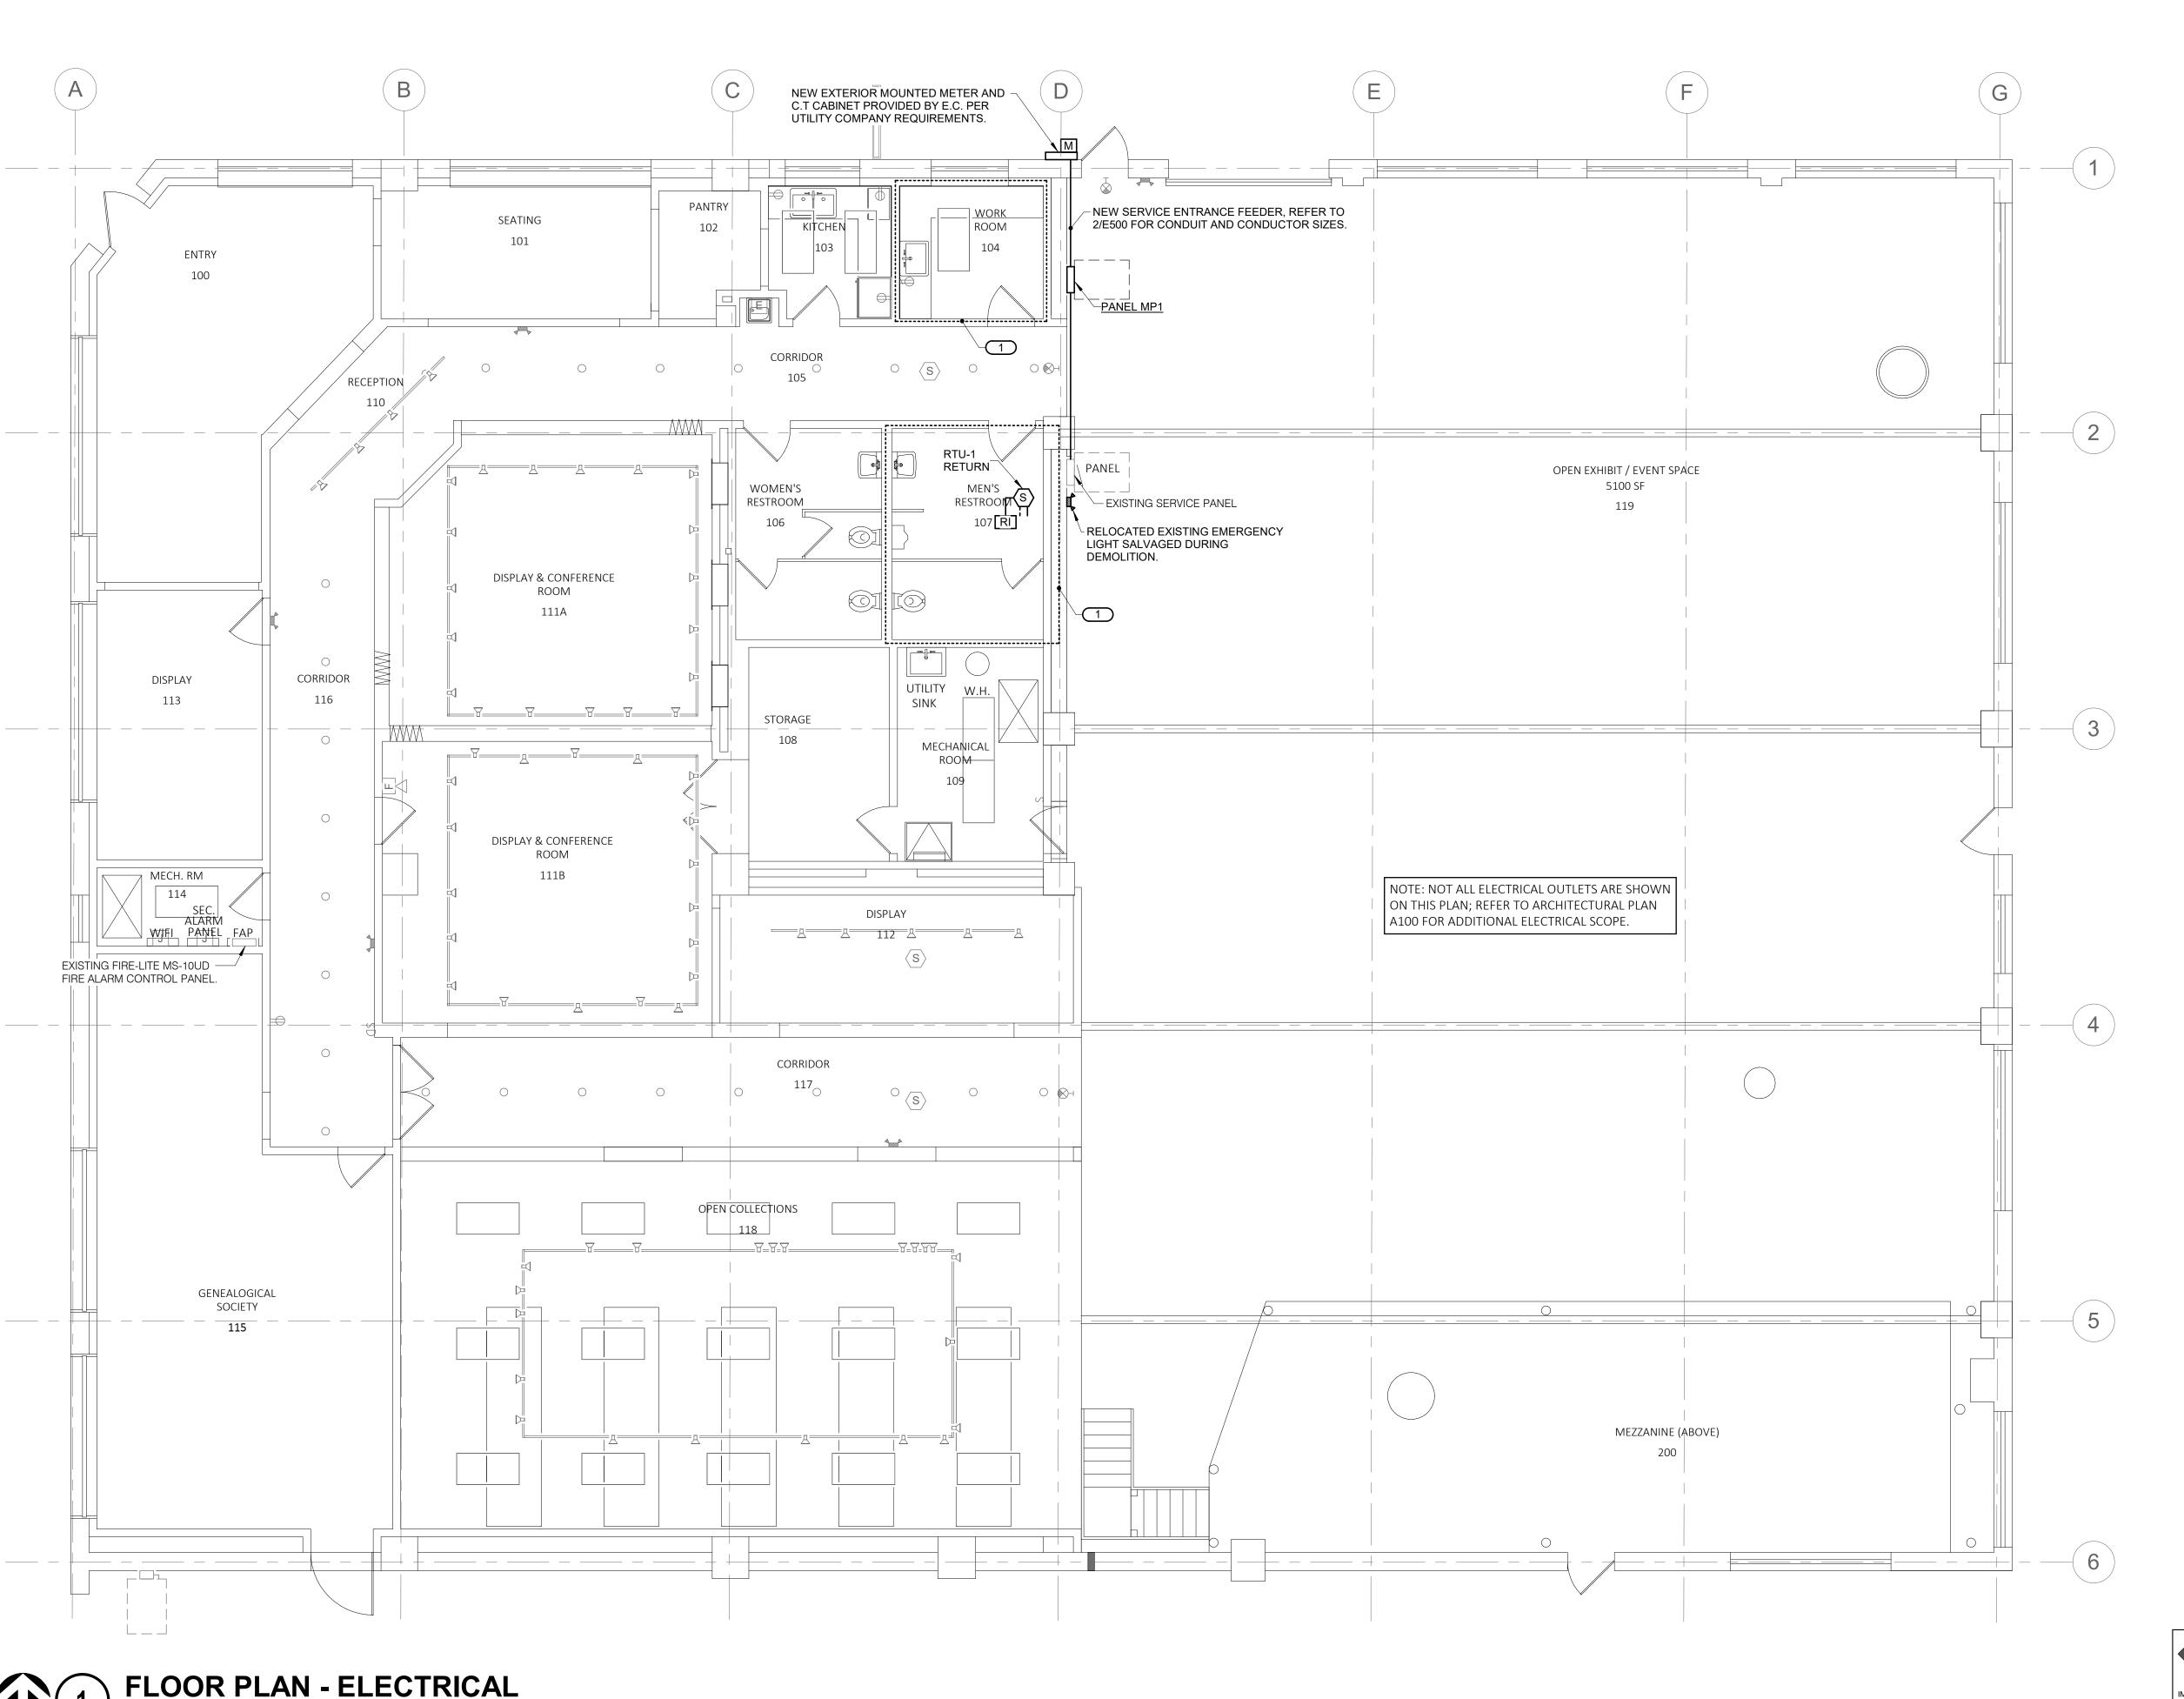

#### SHEET NOTES:

- THERE ARE TWO ALTERNATE BIDS WHICH ARE PART OF THE PROJECT. E.C TO REVIEW ARCHITECTURAL DRAWINGS FOR SCOPE OF WORK REQUIRED.
- EXTEND EXISTING ADDRESSABLE FIRE ALARM WIRING AS REQUIRED FOR NEW DEVICES. PROVIDE ALL NECESSARY PROGRAMMING.

#### KEYNOTES: #

E.C. TO COORDINATE WITH M.C THE INSTALLATION OF NEW DUCTS IN OUTLINED AREA. E.C. TO RELOCATE CONDUITS AND ELECTRICAL EQUIPMENT AS REQUIRED FOR THE INSTALLTION OF NEW DUCTS AND EQUIPMENT. E.C TO REINSTALL LUMINAIRES AND DEVICES AFTER WORK IS COMPLETED.

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NO.	DATE	REMARKS

Seal/Drawing Status:

Not For Construction

Sheet Name FLOOR PLAN -ELECTRICAL

PROJECT NUMBER: 2206-01 DATE: 01/27/2023 DRAWN BY: ADABRO CHECKED BY: Checker SCALE: 3/16" = 1'-0"

E221


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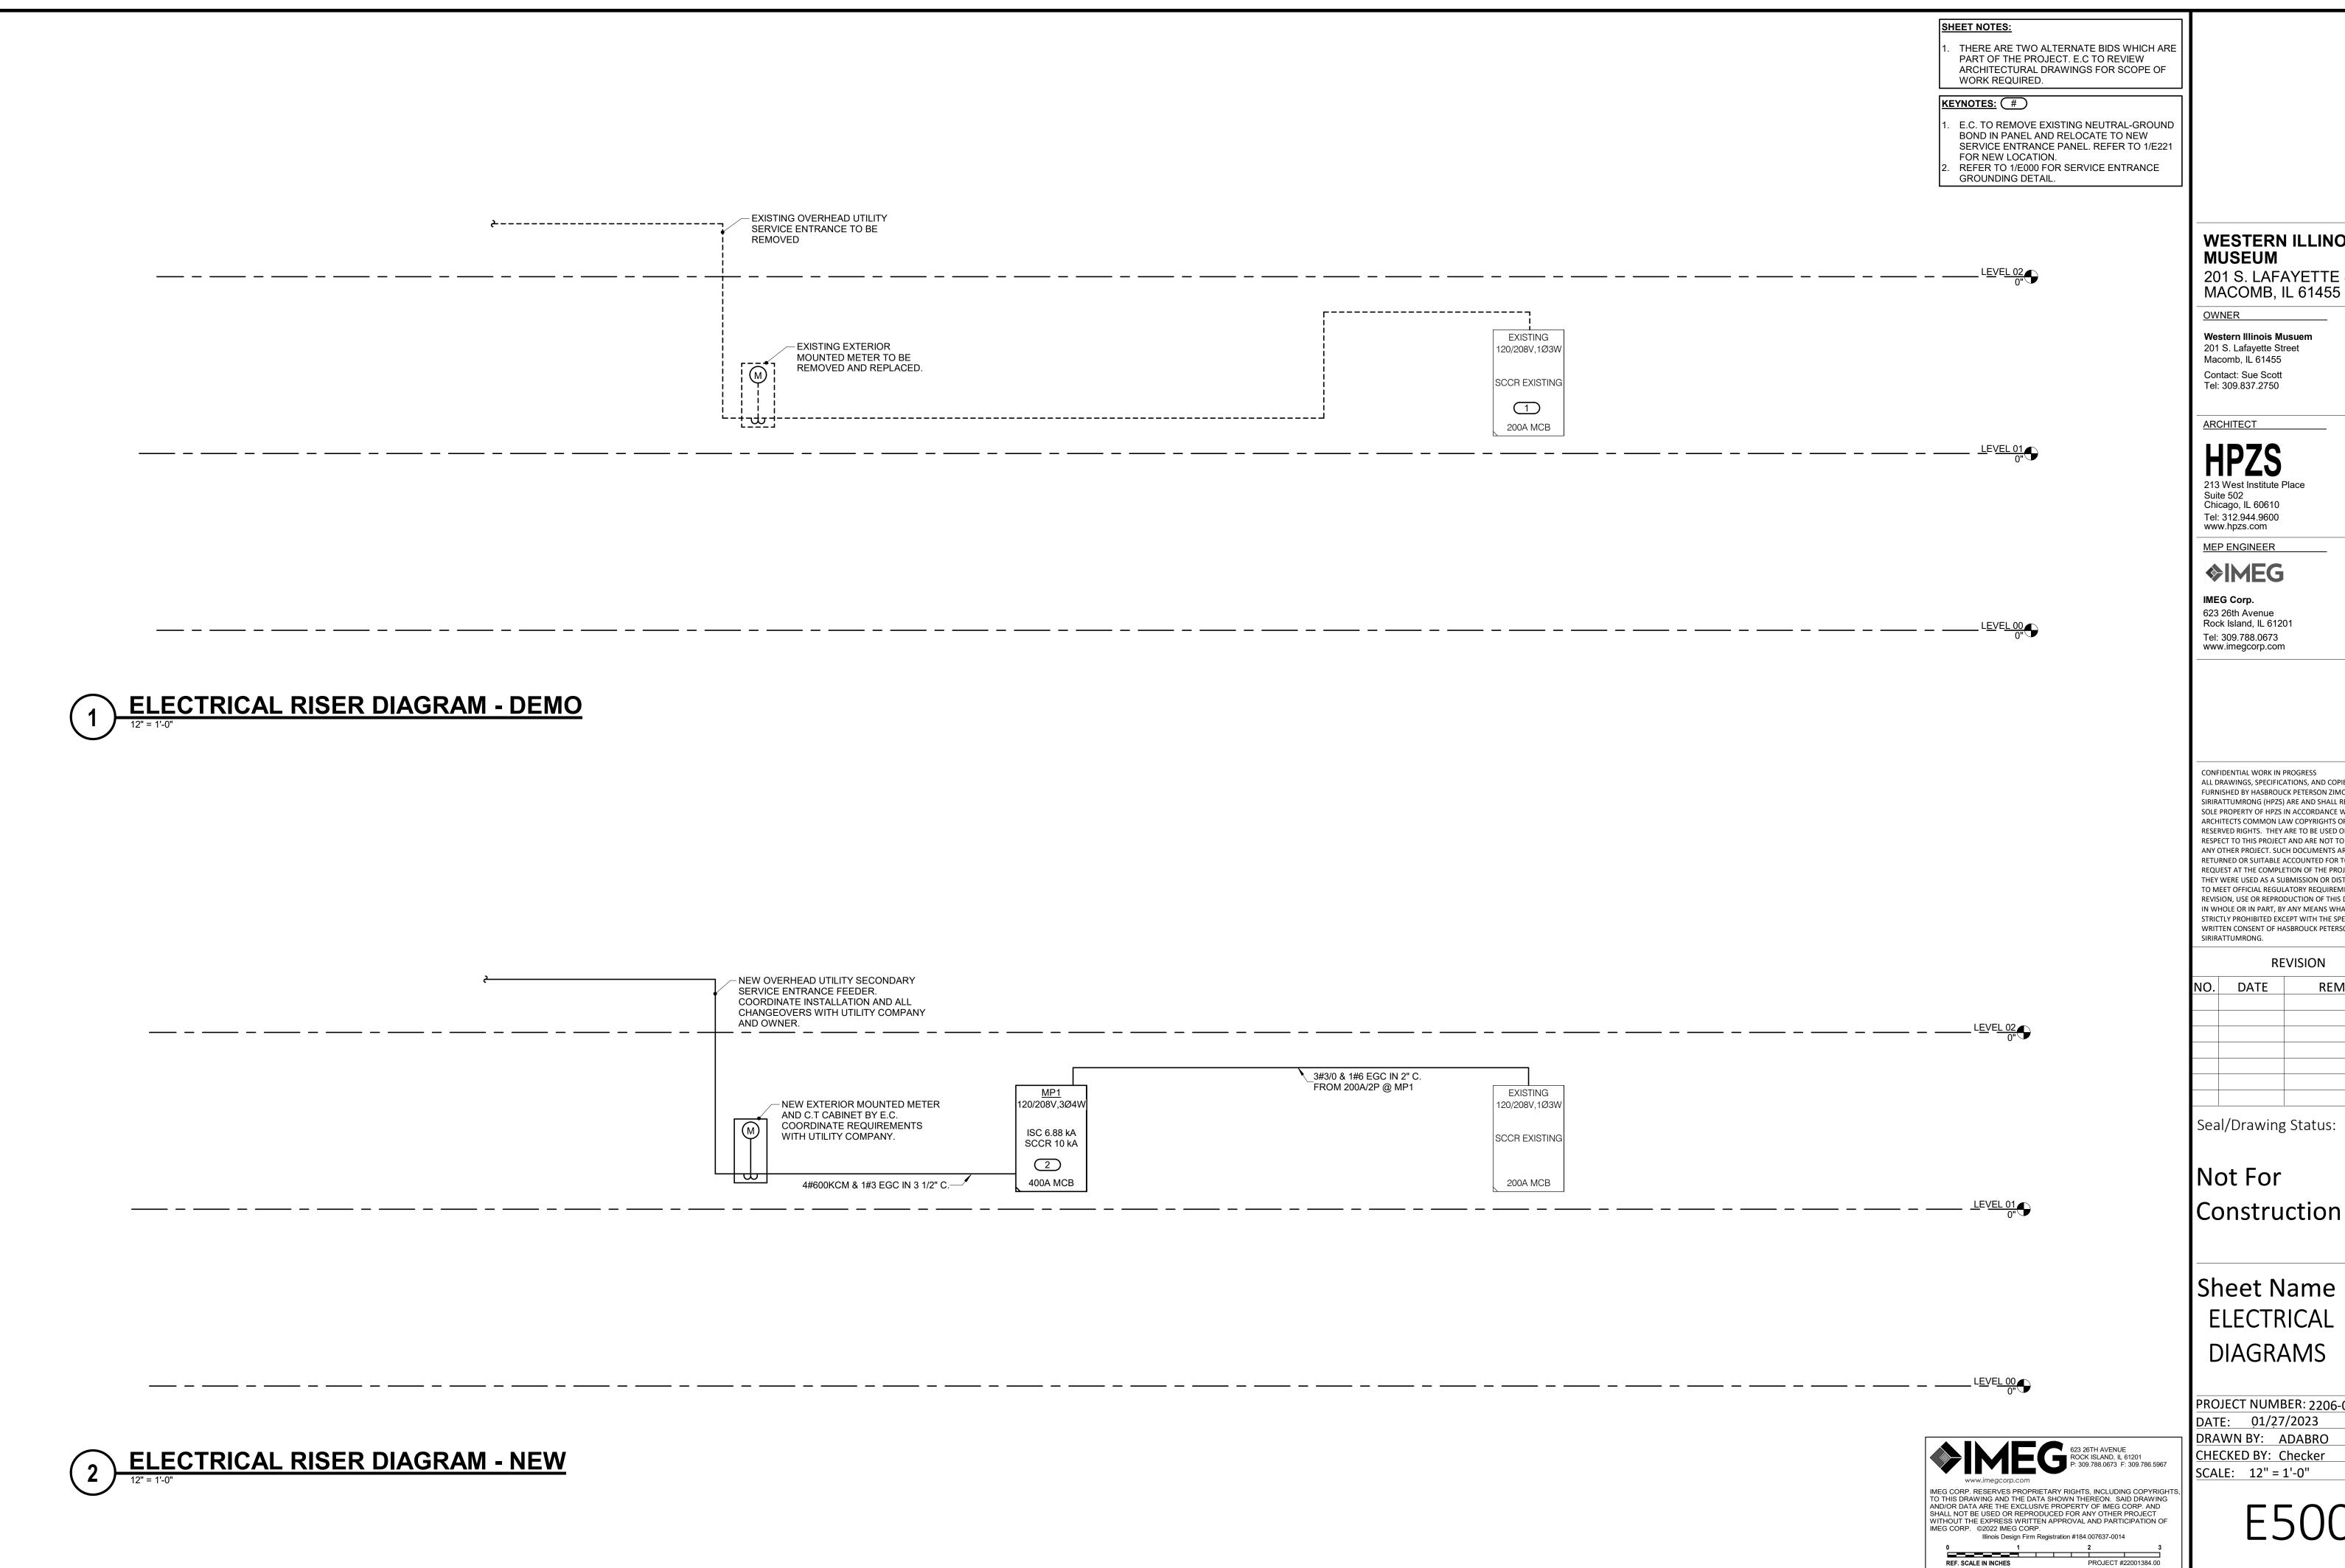
Illinois Design Firm Registration #184.007637-0014

REF. SCALE IN INCHES PROJECT #22001384.00

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FLOOR PLAN - ELECTRICAL



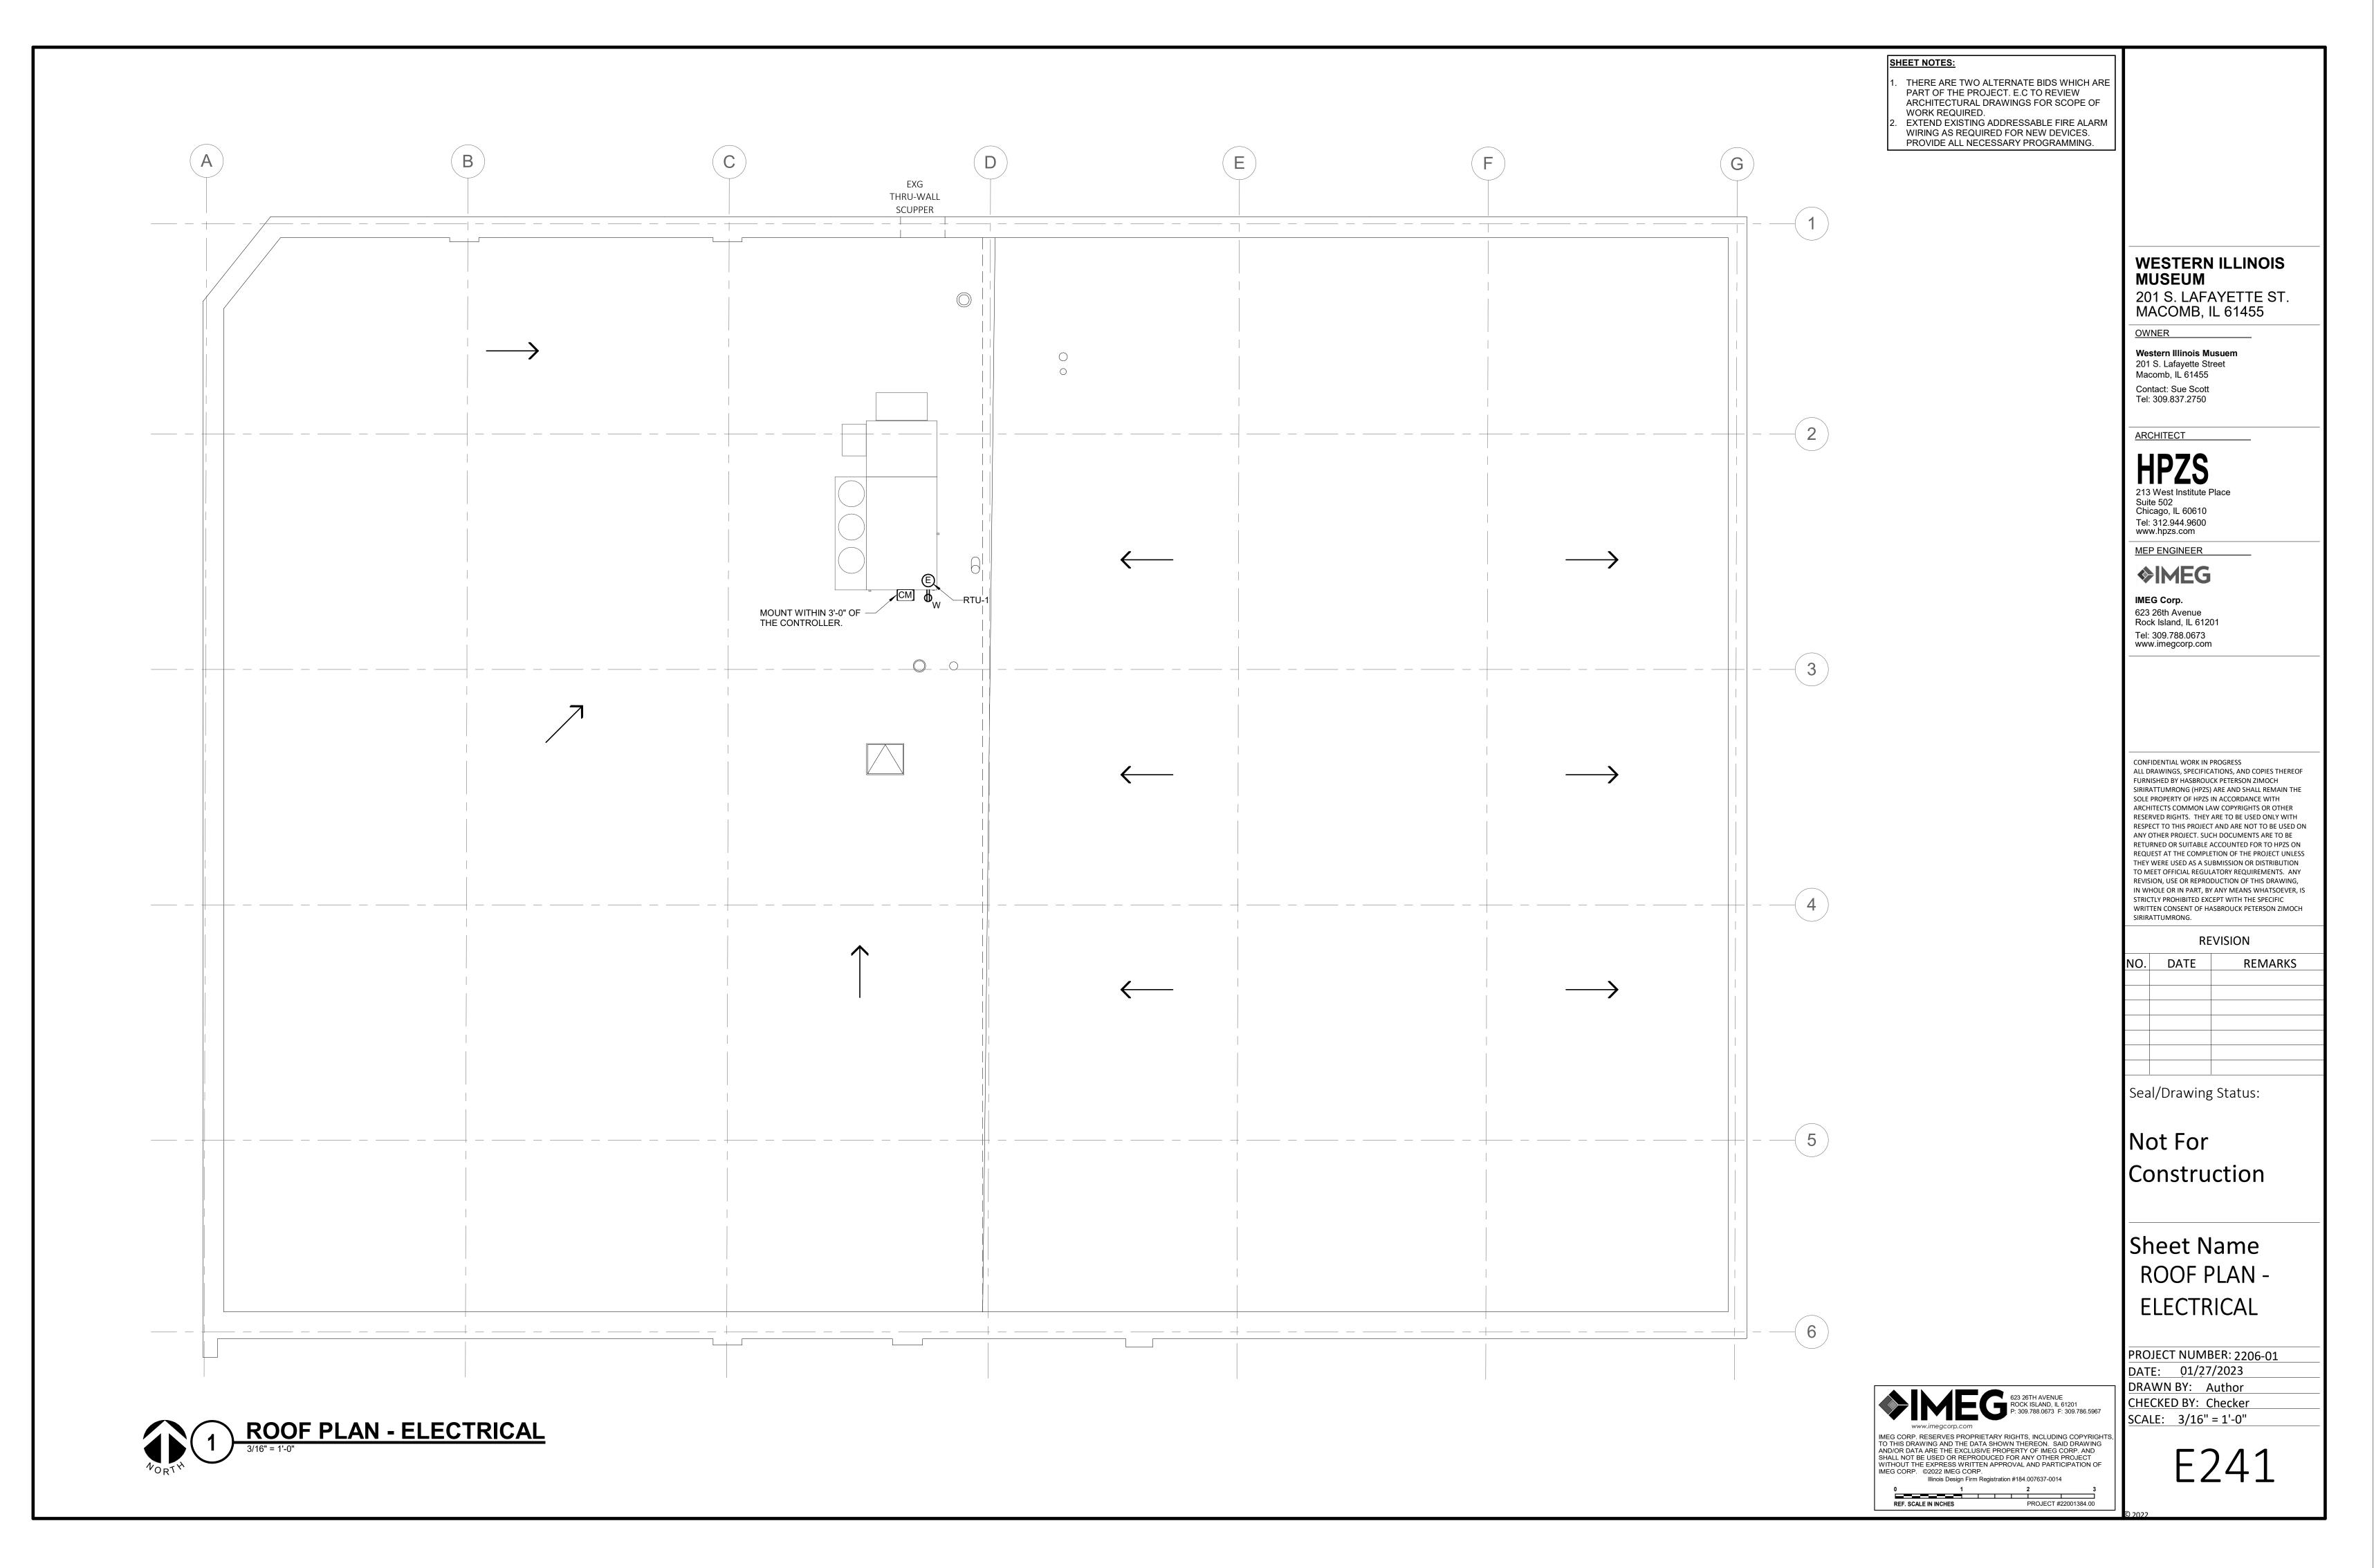

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NO.	DATE	REMARKS

Construction

Sheet Name ELECTRICAL DIAGRAMS

PROJECT NUMBER: 2206-01 DATE: 01/27/2023 DRAWN BY: ADABRO CHECKED BY: Checker

E500